


STD. STEEL LATH SIZES FOR 3/16" BRICK VENEER:	
1 1/2" x 3 1/2" x 14"	MAX ALLOWABLE SPAN OF 3'-1 1/8"
1 3/4" x 3 1/2" x 14"	MAX ALLOWABLE SPAN OF 3'-0 3/4"
1 3/4" x 1 1/2" x 5 1/2"	MAX ALLOWABLE SPAN OF 10'-10 1/4"
1 3/4" x 1 1/2" x 20"	MAX ALLOWABLE SPAN OF 11'-5"

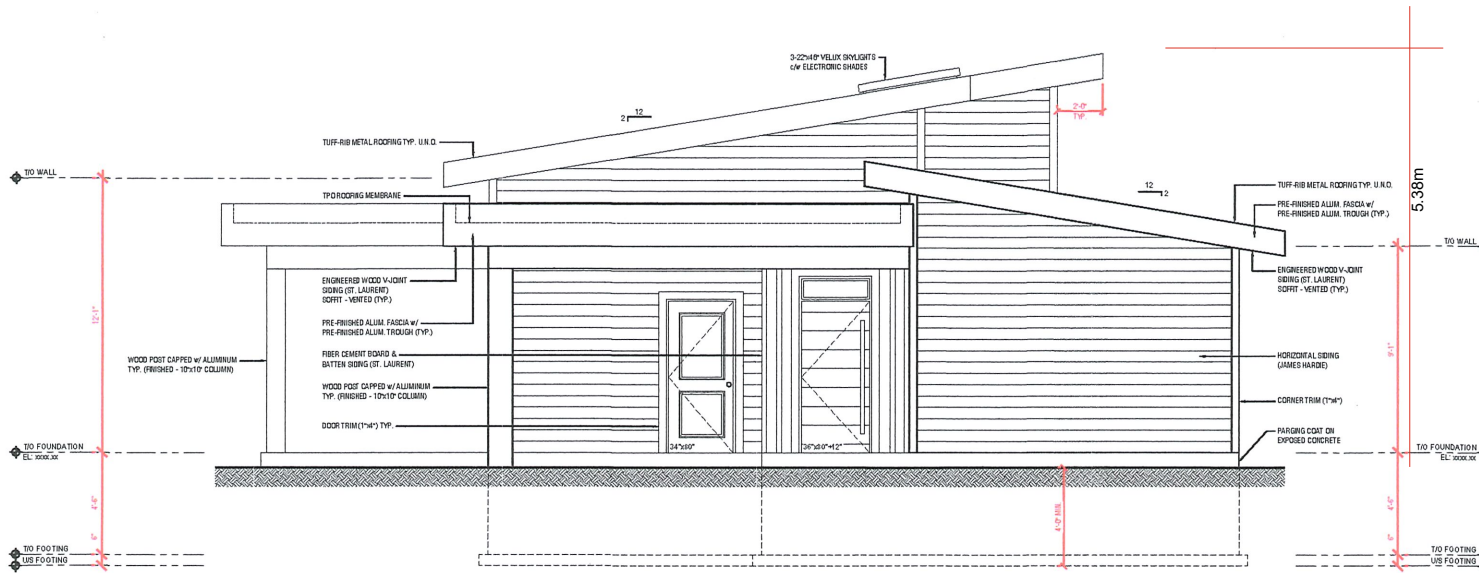

FRONT ELEVATION
 WALL COVERAGE = xxx.xx m² (xxx.xx sq ft) | GLASS COVERAGE = xxx.xx m² (xxx.xx sq ft)
 RATIO OF WINDOW (OPENINGS) TO WALL AREA = xx.x%



9 PRINCESS AVENUE UNIT 5
 ST THOMAS, ONTARIO, N5R 2V3
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AREA CALCULATIONS

MAIN LEVEL	= 1,216 sq ft [112.2 m ²]
FINISHED AREA	= 1,216 sq ft [112.2 m ²]
GROSS AREA	= 1,270 sq ft [117.3 m ²]

LOT SIZE	= xxx sq ft [xxx.x m ²]
HOUSE FOOTPRINT	= 1,765 sq ft [164.0 m ²]
CARPORT FOOTPRINT	= 240 sq ft [22.3 m ²]
HOUSE COVERAGE	= xxx.x%
GARAGE COVERAGE	= xxx.x%

DRAWING SET HAS BEEN COMPLETE
 WITH ACCORDANCE TO OBC 2024

REVISION TABLE	
No.	DESCRIPTION
0	ISSUED FOR PERMIT

PROJECT:
 REDEVELOP RESIDENCE
 LOT # () STREET
 CITY, ON

REGISTERED PLAN XXX-XXX

DATE: MAY 2025

DRAWN BY: XXX

S.C.I.N. XXXXX

SCALE: 3/8" = 1'-0"

FRONT ELEVATION

A2.1

No.