CLIENT: 144658 - 2561603 Ontario Ltd.

PROJECT NAME: Geotechnical Comments Regarding Ravine Crossing Work

PROJECT NUMBER: LON-23002025-A0

Reference: LON-23002025-A0

DATE: October 18, 2023

DATE. October 16, 2023

October 18, 2023

Mr. Deren Lyle, P. Eng.

Cyril J. Demeyere Limited Consulting Engineers 261 Broadway, P.O. Box 460 Tillsonburg, Ontario. N4G 4H8

Dear Mr. Lyle:

Geotechnical Comments Regarding Ravine Crossing Work Eagle Ridge Subdivision - Phase 2, Southdale Line, Central Elgin, ON, Ontario

As requested by Cyril J. Demeyere Limited (CJDL) on behalf of the client, EXP Services Inc. has prepared this letter with geotechnical comments regarding the ravine alteration work located on east side of Hawk's Gate culvert crossing at Eagle Ridge Subdivision - Phase 2, Southdale Line, Central Elgin, Ontario.

The following documents have been received and reviewed:

- The Eagle Ridge, Phase 2 contract drawings (REV 4: Reissued for Construction, 12 Sept 2023) (attached);
- 19012_Geotech Package (Sep-13-2023)_2_3 (attcahed);
- 19012 Sketch of Severance (18 Oct 2023) (attached);
- Results of geotechnical quality assurance inspection and testing services provided by EXP Services Inc.; and
- Recent photographs of the site after construction (attached).

Based on the available documents and photographs, the following were drawn:

- ➤ The Eagle Ridge, Phase 2 contract drawings have been reviewed and approved by the Municipality of Central Elgin and have been constructed.
- Two cross-sections designated as A1&A2 were provided within the attached drawings at the front and rear of the proposed dwelling on Parcel 'C'. The slopes for the open channel were approximately 2.4H:1V and 2.7H:1V (right at the headwall), tapering to 5.6H:1V and 6.5H:1V as moving east (at the rear of the house) with maximum height of the embankment is 2.1m. There is a 3.0 m flat spot beyond the south top of bank, but within the open channel block. CJDL had reviewed/approved with the Municipality of Central Elgin to ensure they could be provided reasonable maintenance access from the south side of the channel.

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➤ Construction of the engineered fill was carried out between September 11 to 25, 2023. During this period of construction of the engineered fill, EXP conducted various visits for quality assurance purposes. The reports show that the subgrade consisted of clayey silt till and the engineered fill consisted of onsite clayey silt within the road embankment construction and imported silty sand for the majority of the ravine crossing fill. Granular materials were used for culvert bedding and embedment as per OPSD and manufacturer's recommendations. EXP completed compaction testing at our discretion, supplemented by visual observations of construction methods and site conditions. Attached are relevant inspection records.

- The filling of the Hawk's Gate right-of-way has been encroached the erosion hazard limits previously applicable in this area.
- > The retaining wall on either side of the Hawk's Gate right-of-way was deleted. The culvert has been extended longer in each direction, complete with a headwall at each end, to facilitate the right-of-way being constructed to a standard cross-section, and then slopes down to match existing on both the east and west sides of the road.
- There are 2x cable concrete mats upstream of the headwall, but the balance of the open channel is vegetated with grass. There is a catchbasin that was installed at the upstream end of the open channel (CB 18A) that intercepts all minor flows from the channel, meaning that it would take a storm event >5-year to actually have flows along the channel and through the culvert. Given the infrequency of utilization of the channel, exposure to erosion is anticipated to be very limited.

Conclusion

All work was completed under the supervision of EXP and was found to be satisfactory and within specifications.

The slopes for the open channel are considered stable and all work completed on the east side of Hawk's Gate has no adverse impact on surrounding areas and is considered acceptable.

Given that the maximum height of the embankment is 2.1m and max inclination is 2.4H:1V, global stability assessment is considered unnecessary and therefore not being performed. Contract Drawing 12 shows that the foundation is below the post-development channel bottom. In the event of erosion, the 3m wide access corridor is provided and can be used to easily maintain/fix anything although it is not expected this will ever need to be used. To this end, EXP concurs with the above entire work and no further study is required from a geotechnical standpoint.


This report has been prepared to accompany forthcoming Consent and Zoning By-Law Amendment applications, to be filed with Elgin County and the Municipality of Central Elgin respectively, for lands located at 42399 Southdale Line. The applicant is proposing to create three (3) single family residential building lots, as shown within the attachments of this report. From a geotechnical standpoint, the proposed lot creation (Parcels 'A', 'B' and 'C') and their foundations will have no adverse impact on the stability of the newly constructed embankments and furthermore the proposed lots might not be

CLIENT: 144658 - 2561603 Ontario Ltd.

PROJECT NAME: Geotechnical Comments Regarding Ravine Crossing Work

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subject to any geotechnical setback restrictions. However, EXP should review foundation details once they are finalized to ensure no further recommendations are required.

We trust this is satisfactory for your current needs. Should you have any questions, please contact this office.

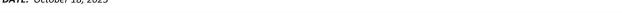Yours truly,

EXP Services Inc.



Adeeb Sadoun, M.Sc., P. Eng. Senior Engineer, Geotechnical Services


Attachments:

Drawings EXP's inspection and testing reports Site photographs



EAGLE RIDGE SUBDIVISION

PHASE 2 - RP 11M-263 DOUG TARRY LIMITED

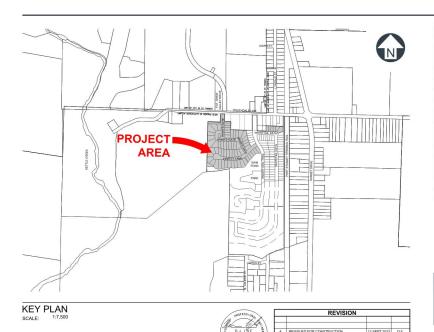

	LIST OF DRAWINGS				
N	TITLE				
1	COVER PAGE				
2	GENERAL PLAN OF SERVICES				
3	GRADING PLAN (NORTH) & EROSION CONTROL PLAN				
4	GRADING PLAN (SOUTH) & EROSION CONTROL PLAN				
5	SANITARY DRAINAGE SYSTEM AND AREAS				
6	STORM DRAINAGE SYSTEM AND AREAS				
7	COMPOSITE UTILITY PLAN (NORTH)				
8	COMPOSITE UTILITY PLAN (SOUTH)				
9	FIREFLY LANE				
10	HAWK'S GATE (SOUTH)				
11	HAWK'S GATE (NORTH)				
12	HAWK'S GATE CULVERT CROSSING				
13	HAWK'S GATE CULVERT SECTIONS & DETAILS				
14	MISCELLANEOUS DETAILS				
15	GENERAL NOTES				



TS

Oyril J. Demeyere Limited

D. Rox 460, 261 Broadway
sonburg, Ontario. NelG 4H8

Tel: 519-684-1006

Fax: 519-642-2225
cjdli@cjdlen.com

CONTRACT #: PROJECT NAME

19012 EAGLE RIDGE SUBDIVISION PHASE 2 - RP 11M-263 DOUG TARRY LIMITED

9012 SCALE: AS NOTED


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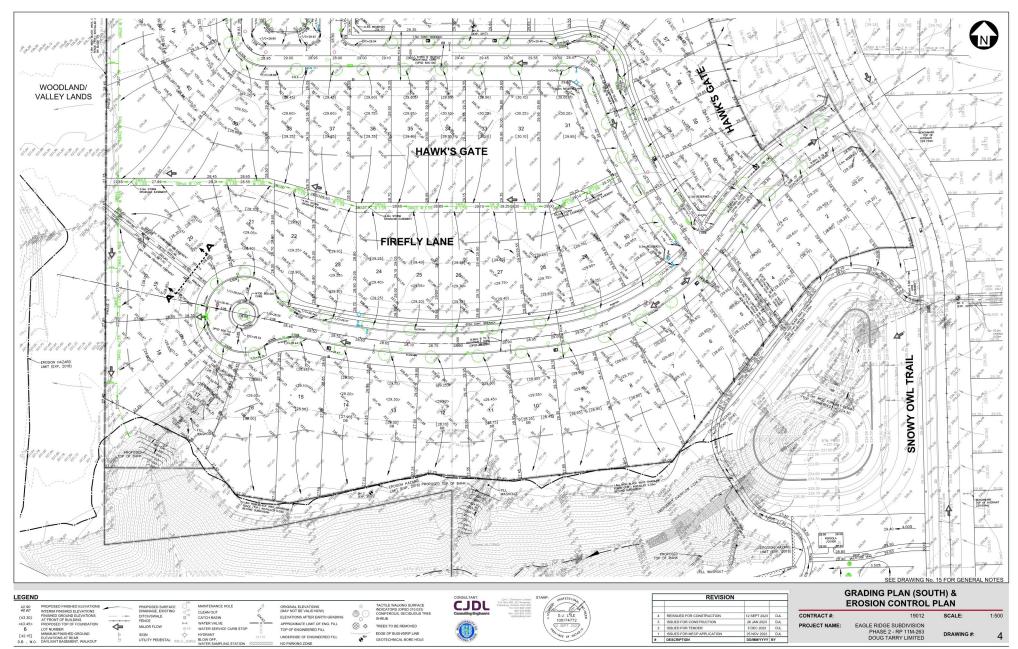
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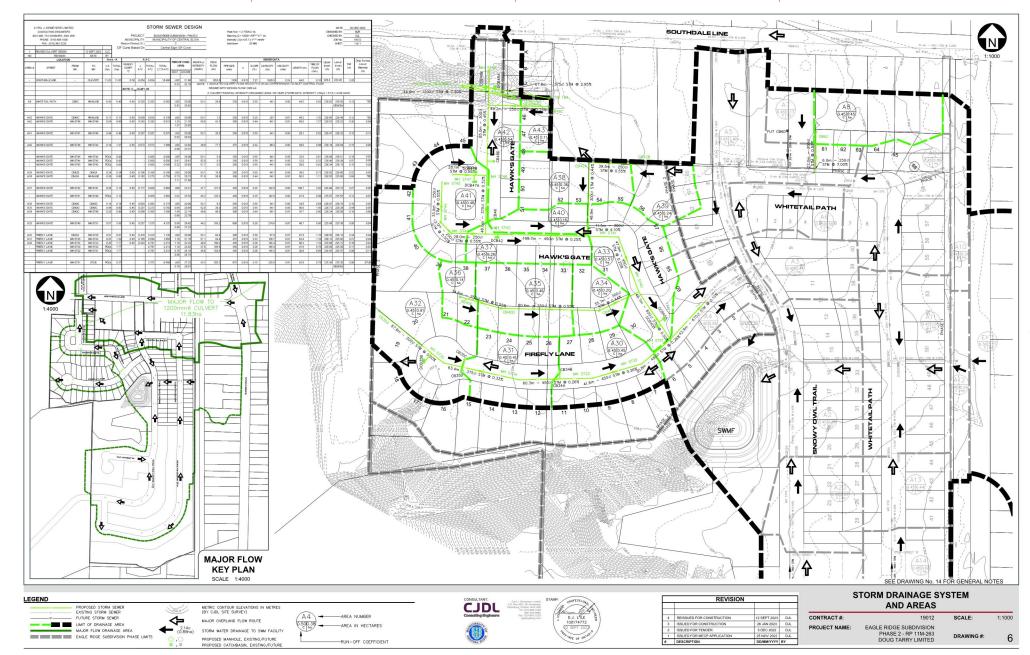
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CJDL
P.O. Brs. 460, 261 Breatvey
Telephone
Consulting Engineers
Fig. 213-343-1000
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Fig. 233-343-2005
Fig. 233 SYSTEM AND AREAS METRIC CONTOUR ELEVATIONS IN METRES
(BY CUDL SITE SURVEY)


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- EXISTING SANITARY SEWER
- FUTURE SANITARY SEWER
- PROPOSED MANHOLE, EXISTING/FUTURE CONTRACT #: SCALE: 1:1000 3 ISSUED FOR CONSTRUCTION
2 ISSUED FOR TENDER
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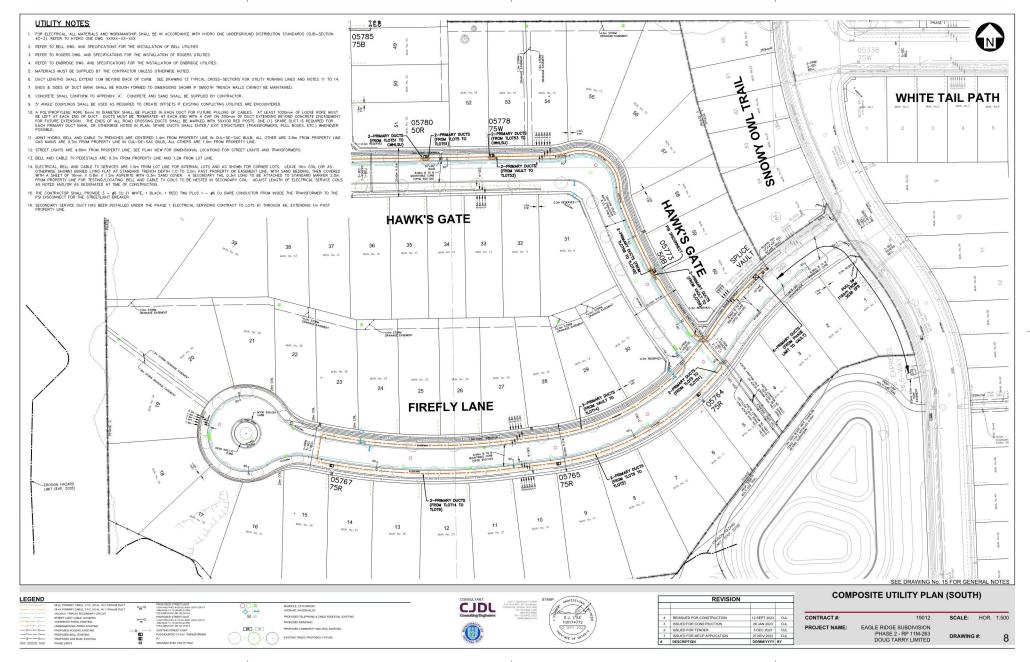


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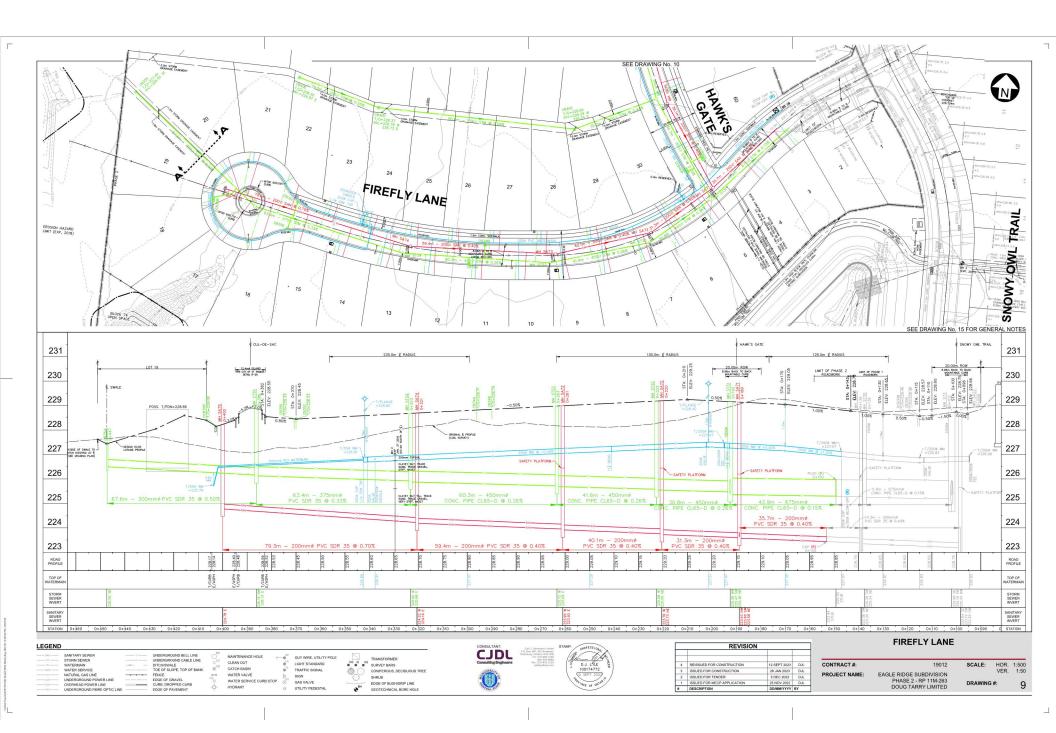



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SEE DRAWING No. 10 **HAWK'S GATE** GATE HOSPASSINS NHUM WSD D S HAWK. 38 GATE HAWK'S GATE HAWK. HAWK'S GATE **HAWK'S GATE** 83 45 SEE DRAWING No. 15 FOR GENERAL NOTES SEE RIGHT SOUTHDALE LINE LIMIT OF EAGLE RIDGE SUBDIVISION - PHASE 2 231 231 231 231 10.00m ©
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E-0.82% ALONG © CONST. 20.00m R.O.W. 8.96m BACK TO BACK MOUNTABLE CURB 20.00m R.O.W. B.96m BACK TO BACK MOUNTABLE CURB 230 230 230 230 STA: C 229 229 229 229 228 228 228 228 227 T/200# WM = =226.95 227 227 227 226 226 226 226 CLAYEY SLT TILL, TRACE SAND, TRACE CRAVEL, STIFF TO VERY STIFF, MOST 225 225 225 225 SEE DRAWING NO. 12 & 13-FOR CULVERT CROSSING DETAILS 224 224 224 224 300mmø PVC SDR 35 @ 0.45% 48.0m - 375mmø PVC SDR 35 @ 0.32 28.1m - 250mmø PVC SDR 35 @ 0.55% 223 223 223 223 46.8m - 200mmø PVC SDR 35 @ 1.20% 95.5m - 200mmø PVC SDR 35 ⊗ 0.70% 222 222 222 222 12.0m - 200mmø PVC SDR 35 @ 0.70% 221 221 221 221 TOP OF TOP OF TOP OF VATERMAIN STORM SEWER INVERT STORM SEWER INVERT STORM SEWER INVERT HAWK'S GATE (NORTH) REVISION LEGEND CJDL SANITARY SEWER
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UNDERGROUND CABLE LINE
DITCH/SWIALE
TOE OF SLOPE, TOP OF BANK
FENCE
EDGE OF GRAVEL
CURB, DROPPED CURB
EDGE OF PAVEMENT MAINTENANCE HOLE CHY WIRE LITH ITY POLE CLEAN OUT LIGHT STANDARD TRAFFIC SIGNAL RIB IB SIB SURVEY BARS SCALE: HOR. 1:500 VER. 1:50 CONTRACT #: CATCH BASIN WATER VALVE CONIFEROUS, DECIDUOUS TREE SHRUB EDGE OF BUSH/DRIP LINE ISSUED FOR CONSTRUCTION 26 JAN 2023 D.JL 5 DEC 2022 D.JL 25 NOV 2022 D.JL EAGLE RIDGE SUBDIVISION PHASE 2 - RP 11M-263 DOUG TARRY LIMITED PROJECT NAME: WATER SERVICE CURB STOP DRAWING #: HYDRANT GEOTECHNICAL BORE HOLE # DESCRIPTION DD/MM/YYYY BY

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42399 GATE HAWK'S GARAGE APPROX. LIMIT OF DISTURBANCE RESTORE WITH 150mm TOSOIL AND HYDROSEES (PR OPSD 209.1 SEE DRAWING No. 3 FOR SEDIMENT CONTROL NOTES SEE DRAWING No. 15 FOR GENERAL NOTES # HAWK'S GATE 230 230 233 25.6m R.O.W. 8.96m BACK TO BACK MOUNTABLE CURB (OPSD 600.100) 232 AT BED 231 229 229 . 4.48m 4.48m 230 LOT D POS. T/FDN = 28.75 228 APPROX LIMIT OF DISTURBANCE RESTORE WTH ISOMON(MH) TOPSOR, AND SEED 228 229 - DESIGN C/O LOTUNE PROFILE 228 227 227 227 COMPACTED CLAY SEAL CRANULAR B TO BE PLACED 0.3m ABOVE CILLVERT 226 226 226 225 224 225 225 223 ORIGINAL PROFILE GRADE O CL OF RAVINE 222 224 224 CROSS-SECTION 'E-E' LOT C/D STORM DRAINAGE EASEMENT LOOKING EAST 223 223 222 222 SECTION D-D OR. 1:200 VER. 1:50 LOOKING NORTH HOR. 1:200 67.8m - 375mmøPVC SDR 35 @ 2.95% 221 221 PROFILE PROFILE GRADE HAWK'S GATE CULVERT CROSSING REVISION LEGEND CJDL SANITARY SEWER
STORM SEWER
WATERMAIN
WATER SERVICE
NATURAL GAS LINE
UNDERGROUND POWER LINE
OVERHEAD POWER LINE
UNDERGROUND FIBRE OPTIC LINE UNDERGROUND BELL LINE
UNDERGROUND CABLE LINE
DITCH/SWIALE
TOE OF SLOPE, TOP OF BANK
SILT FENCE
EDGE OF GRAVEL
CURB, DROPPED CURB
EDGE OF PAVEMENT TRANSFORMER
SURVEY BARS
CONFEROUS, DECIDIOUS TREE
SHRUB
EDGE OF BUSHDRIP LINE
GEOTECHNICAL BORE HOLE MAINTENANCE HOLE GUY WIRE, UTILITY POLE CLEAN OUT LIGHT STANDARD TRAFFIC SIGNAL SCALE: HOR. 1:200 VER. 1:20 CONTRACT #: 19012 CATCH BASIN WATER VALVE ISSUED FOR CONSTRUCTION 26 JAN 2023 DJL 5 DEC 2022 DJL 25 NOV 2022 DJL EAGLE RIDGE SUBDIVISION PHASE 2 - RP 11M-263 DOUG TARRY LIMITED PROJECT NAME: WATER SERVICE CURB STOP DRAWING #: 12 HYDRANT # DESCRIPTION DD/MM/YYYY BY
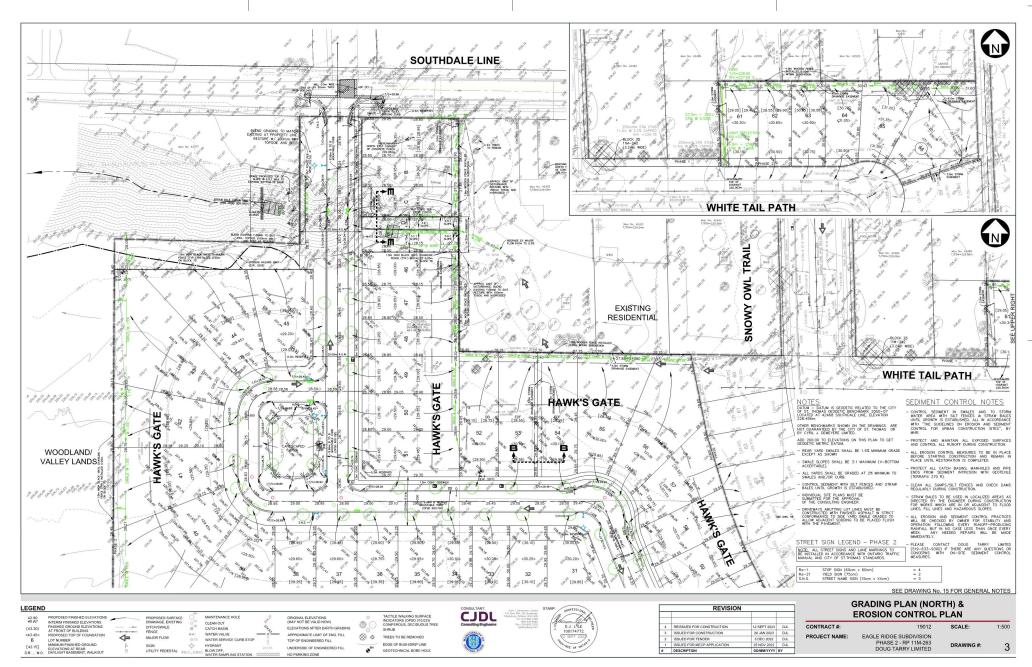
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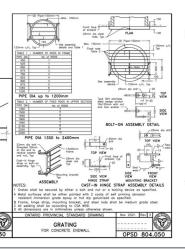
- ONCE CONSTRUCTION BEGINS EVERY EFFORT SHOULD BE MADE TO COMPLETE THE WORKS EXPEDITIOUSLY. IF AN UNEXPECTED RUNGIF EVENT IS EXPERIENCED DURING THE CONSTRUCTION, SAFETY, ENVIRONMENTAL/SEDMENT CONTROL AND CONSTRUCTION INTEGRITY MUST BE REGARDED. DECISIONS IN THIS REGARD, ARE AT THE DISCRETION OF THE SUPERVISING DEVALUES.
- 2. SEDIMENT LOADING MUST SE MANAGED AT ALL TIMES SEY PLACING SIX TRIVES (MITH STRAM BALES, IF REQUIRED) ADJACENT CONSCIOUS CUBHANMENT, ADJACENT TO RANNE CHANNEL, AND ARROWN OWN STEELS OF DESCRIBED AND STRAM STATE OF CONTRACTOR TO BEACTER UNITED WHITE ADJACENT AS DIRECTED WITH PROJECT IS ACCEPTED. THE CONTRACTOR SHALL RETURN TO REMOVE THE SLIT FEMES AND/OR STRAM BALES UPON ESTABLISHMENT OF GROWTH AT NO EXTRA COST. ANY ACCUMULATED SLIT SHALL PREMOVED AT RECOVERY ANTERVALS AT NO ADDITIONAL COST TO THIS PROJECT.
- 3. STUMPS SHALL BE REMOVED AND DISPOSED OFF-SITE. CONTRACTOR TO STRIP TOPSOL FROM AREAS TO RECEIVE CLAY FILL ON ROADWAY AREA AND FROM CULVERT AND STREAM REALISMENT AREAS. NOTE: TOPSOL TO BE RE-USED AS FILL. ROOT INVESTED TOPSOL. INCLUDING SMALL STUMPS AND MIXED FILL, SHALL BE DISPOSED OF OFFSITE. BALANCE OF TOPSOLS TO BE USED FOR SLOPE SEROPATORY/FILE.
- 4. PRECAST 1200mm# CONCRETE CULVERT IS DIMENSIONED AND SHALL BE AS MANUFACTURED BY M CON PIPE & PRODUCTS INC. 1-866-537-3338 OR APPROVED EQUAL, IN ACCORDANCE WITH THE LATEST EDITION OF THE CANADIAN HIGHWAY BRIDGE DESIGN CODE (CHBDC) CAN/CSA-S6 AND SEALED BY A LICENSED PROFESSIONAL DIGINEER.
- 5. CULVERT SECTION D-D MEW IS LOCATED AT THE CENTER LINE OF THE PROPOSED CULVERT, PERPENDICULAR TO HAWK'S GATE RIGHT-OF-WAY. THEREFORE CULVERT IS PROJECTED ONTO SECTION D-D, REFER TO DRAWNO No. 12 FOR PLAN DIMENSIONS.
- 6. ALL POURED CONCRETE MUST BE FORMED AND SHALL BE IN ACCORDANCE WITH SPECIFICATIONS. ALL EXPOSED CORNERS SHALL BE CHAMFERED 20 mm.
- REINFORCING STEEL SHALL BE EPOXY COATED GRADE 400, CSA TSD. 630-12. BENDING AND FABRICATION TO BE IN ACCORDANCE WITH A.C.I. SPECIFICATIONS. CLEAR COVER ON REINFORCING STEEL SHALL BE 75 mm.
- 8. ALL RIP-RIP (OPSS 1004) C/W GEOTEXTILE UNDERLAY IN ACCORDANCE WITH OPSD 810.010 PLACED TO LIMITS SHOWN ON PLAN AND SECTIONS SEE DWG No. 3 & 12
- 9. COMPACTION, LIFTS AND FILL SHAPING OF ROADWAY/RAWINE FILL SHALL BE PER GENERAL NOTES. PLACE CLAY FILL AND TOPSOIL CONCURRENTLY TO MAINTAIN VERTICAL KNRT INTERFACE.
- 10. ALL ABUTTING LIMITS DISTURBED SHALL RECEIVE 150 mm TOPSOIL AND SEED. SEED EMBANKMENT SIDE SLOPES. CONTRACTOR SHALL RETURN TO CORRECT ANY EROSION AND SHALL BE RESPONSIBLE FOR MAINTENANCE UNTIL GROWTH IS ESTABLISHED.
- 11. A MAXMUM GAP OF TSmm WILL BE ACCEPTABLE IN JOINTS BETWEEN CULVERT SECTIONS WITHOUT GROUT INSIDE IF CULVERT, SECTIONS SHOULD BE PULLE TOOCETHER WITH A COME-ALONG TO MINIMIZE JOINT SPACING. JOINTS EXCEEDING 15mm SHALL BE GROUTED ON INSIDE OF CULVERT.
 SHOP DRAWNOSS.

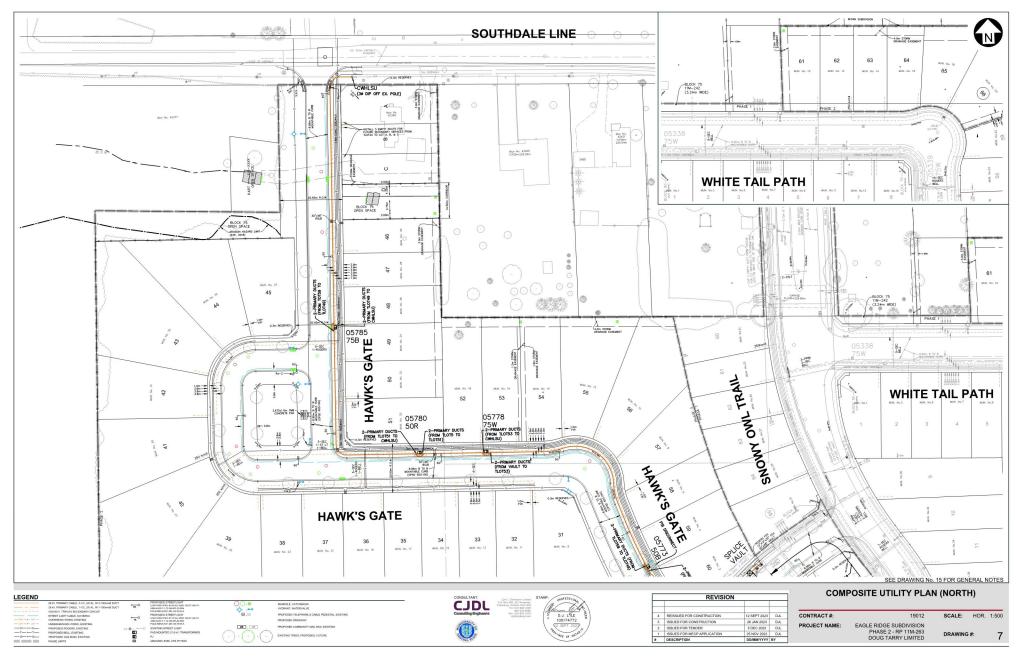
THE CONTRACTOR SHALL SUBMIT SHOP DRAWINGS TO THE ENGINEER IN ACCORDANCE WITH TABLE 1(THIS SHEET) FOR APPROVAL.


SHOP DRAWINGS SHALL BE REVIEWED BY THE CONTRACTOR FOR DIMENSIONAL CORRELATION WITH THE DRAWINGS AND FIELD CONDITIONS PRIOR TO SUBMITTING TO THE ENGINEER.

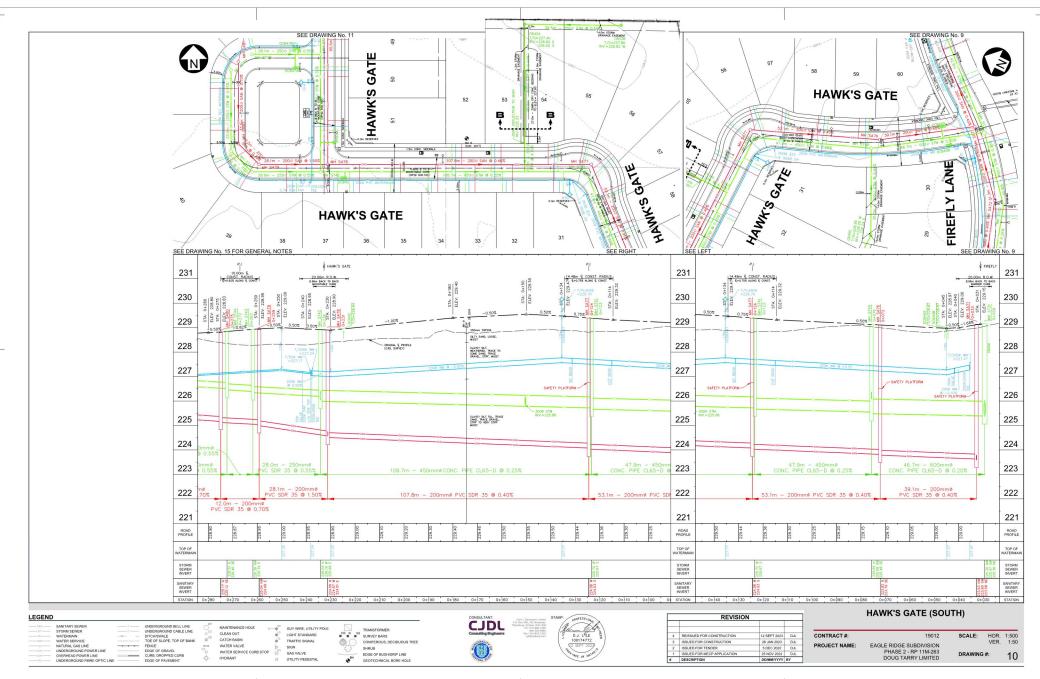
TABLE 1: SHOP DRAWING SUBMITTALS

ITEM	REQUIRED SUBMITTAL	PROFESSIONAL ENGINEER SEA REQUIRED	
CONCRETE MIX DESIGNS	YES	NO	
GRANULAR GRADATION	YES	NO	
MISC. METALS (INCLUDING PEDESTRAIN BARRICADE)	YES	NO	
PRECAST HEADWALLS	YES	YES	



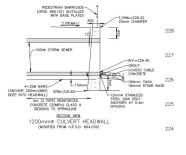

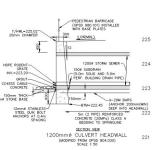

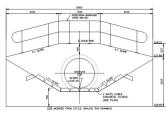

1200mmø CULVERT INLET HEADWALL (INCL. GRATING PER OPSD 804.050) SCALE 1:50



1200mm@ CULVERT OUTLET HEADWALL (NCL GRATING PER 0PSD 804.050) SCALE 1:50

LEGEND

SANITARY SEWER

BI STORM SEWER

WATERMAIN

WATER SERVICE

O NATURAL GAS LINE

UNDERGROUND POWER LINE

UNDERGROUND FIBRE OPTIC LINE

UNDERGROUND BELL LINE
UNDERGROUND CABLE LINE
DITCH/SWIALE
TOE OF SLOPE, TOP OF BANK
FENCE
EDGE OF GRAVEL

EDGE OF PAVEMENT

PEDESTRIAN BARRICADE

MAINTENANCE HOLE

CLEAN OUT

CATCH BASIN

WATER VALVE

WATER SERVICE CURB STOP

HOTERANT

GUY WIRE, UTILITY POLE
LIGHT STANDARD
TRAFFIC SIGNAL
SIGN
GAS VALVE

TRANSFORMER
SURVEY BARS
CONTEROUS, DECIDIOUS TREE
SHRUB
EDGE OF BUSHDRIP LINE
GEOTECHICAL BORE HOLE

CONCRETE HEADWALL
FOR PIPE LESS THAN 900mm DIAMETER






	REVISION							
4	REISSUED FOR CONSTRUCTION	12 SEPT 2023	DJL					
3	ISSUED FOR CONSTRUCTION	26 JAN 2023	DJL					
2	ISSUED FOR TENDER	5 DEC 2022	DJL					
1	ISSUED FOR MECP APPLICATION	25 NOV 2022	DJL					
	DESCRIPTION	DD/MM/YYYY	BY					

HAWK'S GATE CULVERT SECTIONS & DETAILS

CONTRACT #: 19012 SCALE: AS SHOWN
PROJECT NAME: EAGLE RIDGE SUBDIVISION PHASE 2 - RP 11M-263 DOUGT FARRY LIMITED DRAWING #: 13

4209/911394 Leptock/9912,FU3.evg, 3823 89 12 41038744, CIRUCO

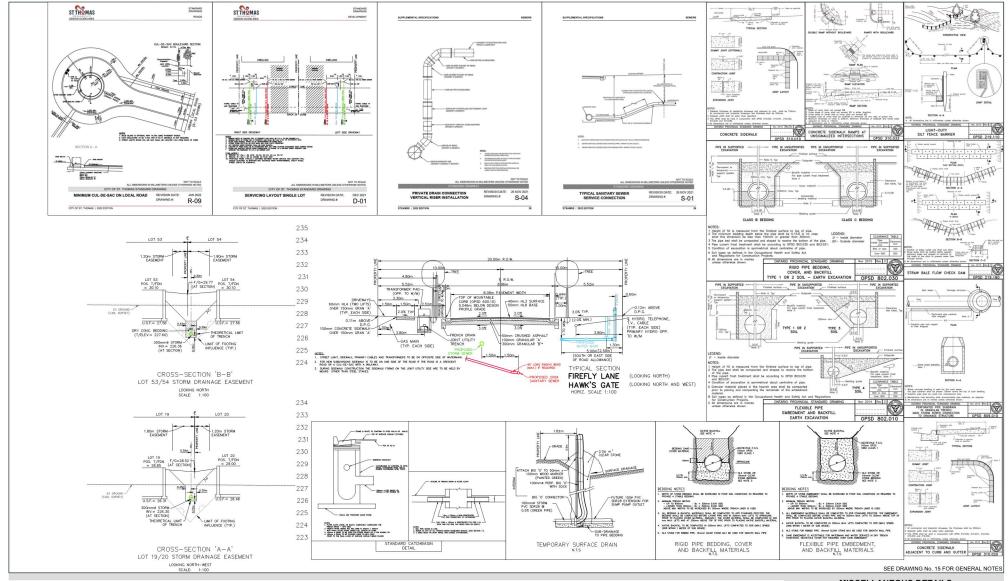


MISCELLANEOUS DETAILS CONTRACT #: SCALE: AS SHOWN EAGLE RIDGE SUBDIVISION PHASE 2 - RP 11M-263 DOUG TARRY LIMITED PROJECT NAME: DRAWING #:

CJDL



4 REISSUED FOR CONSTRUCTION 12 SEPT 2023 D.I. 3 ISSUED FOR CONSTRUCTION 26 JAN 2023 D.I. 2 ISSUED FOR TENDER 5 DEC 2022 D.I. 1 ISSUED FOR WECP APPLICATION 25 NOV 2022 D.I.		DESCRIPTION	DD/MM/YYYY	BY
3 ISSUED FOR CONSTRUCTION 26 JAN 2023 DJL	1	ISSUED FOR MECP APPLICATION	25 NOV 2022	DJL
	2	ISSUED FOR TENDER	5 DEC 2022	DJL
4 REISSUED FOR CONSTRUCTION 12 SEPT 2023 DJL	3	ISSUED FOR CONSTRUCTION	26 JAN 2023	DJL
	4	REISSUED FOR CONSTRUCTION	12 SEPT 2023	DJL
		REVISION		

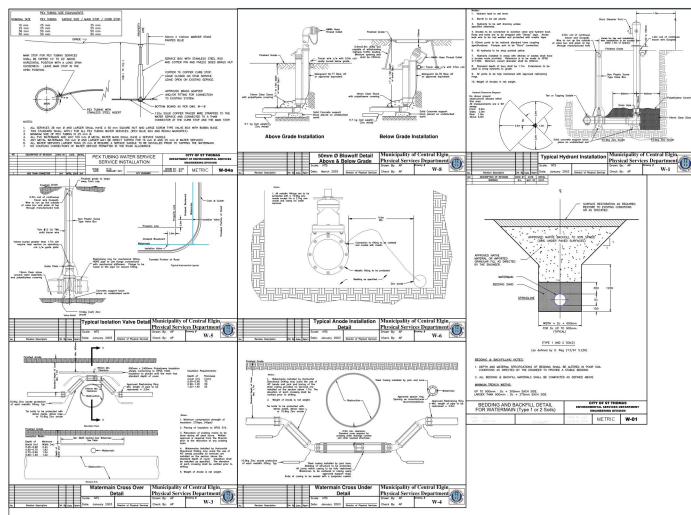

GENERAL NOTES

- TIME IS OF THE ESSENCE. REFER TO ADDENDUM NO. 1. THE CONTRACTOR SHALL CO-OPERATE WITH ANY UTILITY COMPANIES WHO MAY BE ON SITE.
- DATUM IS GEODETIC RELATED TO CITY BENCHMARK 2000-07 AT 42468 SOUTHDALE LINE, ELEVATION 228.456m. OTHER BENCHMARKS SHOWN ON THE DRAWINGS ARE NOT GUARANTEED BY THE MUNICIPALITY OF CENTRAL ELGIN OR BY CYRIL J. DEMEYERE LIMITED.
- THE CONTRACTOR SHALL VERIFY ALL MEASUREMENTS AND REPORT ANY DISCREPANCIES TO ENGINEER FOR RESOLUTION BEFORE STARTING CONSTRUCTION. ALL CHAINAGES ARE ALONG CENTRELINE OF ROAD ALLOWANCES, EASEMENTS OR WALKWAYS LINLESS OTHERWISE NOTED.
- THE CONTRACTOR SHALL MAINTAIN THE FLOW OF ALL EXISTING DRAINS ENCOUNTERED AT ION AGRICUATIONAL COST, WHERE SHOWN ON PRANINGS ON NOT, AND SHALL, WHERE REQUISTED, CONNECT THE DRAINS INTO SANTHAY OR STORM SEWERS. CONNECTIONS SHALL BE FAND AT UNIT MORPHONE OF THE CONNECTIONS SHALL BE FAND AT UNIT MORPHONE OF THE CONNECTION SHALL BE FAND THE OWNER AND THE PROPERTY OF THE OWNER SHALL BE FAND THE OWNER AND THE PROPERTY OF THE OWNER SHALL BE FAND THE OWNER AND THE OWNER SHALL BE FAND THE O
- ALL SPEES OR WITEMANS, MILLURIC CATORIASS LEADS AND PRIVATE DRAW CONNECTIONS, WITHER DISTING OR NITHALED BY THE CONTRACT, WHICH ARE EXPOSED BY A TRECH, EXPONITED OR A PIZE CORSON TO DE RESTALLED AT A LOKES GAZE OR MIDDERNALED BY THE CARY OR ANY OTHER RECORD SHALL BE SUPPORTED WITH MELL, COMPACTED STORE EXTENDED EXTENDING TO THE LOKES PIZE EXCEDING. IF THE RECORDING ANY OTHER SHALL BE SUPPORTED WITH MELL COMPACTED STORE EXTENDED EXTENDING TO THE LOKES PIZE BY THE LOKES AND THE CONTRACT OF THE WITH A 100-PAGE THAT OF THE WITH OTHER OF THAT OF THE WITH OTHER OF THE WITH OTHER OTHER OTHE
- ALL MANINES, ME 1200-MINE URLES CHIERMES OFFICIAL OF ROTILES ALL MANINES SHALL BE EXPORTED FOR FITTING CONFICTIONS.

 MANINESIS SHALL BE ADMINISTED THE CONFICTIONS AND ADMINISTED FOR ADMINISTRATION OF A CONFIDENCE DURST THE CONFICTIONS AND ADMINISTRATION OF A CONFIDENCE DURST THE STATE OF A CONFIDENCE DURST THE STATE OF A CONFIDENCE DURST THE CONFIDENCE DURST THE CONFIDENCE OF A CONFIDENCE DURST THE CONFID
- REID COUNTED FOR STORM SERVERS OCOMMENDED FOR JOSCOBA.

 REBED COUNTED FOR STORM SERVERS OCOMMENDED FOR SHATLARY SEWERS, MATERIAL MUST BE PVC SMOOTH WALL REBED COUNTED AT THE USED FOR STORM SEWERS OCOMMEND AS A SHATLARY SEWERS. POWER STORM SEWERS OCOMMEND AND ASSESSMENT WITH CONCRETE BEDOND, MILESS OTHERWER HOTD MANUAL PROPERTY OF STORM SEWERS OCCUPANT OF STORM SEWERS OF STORM SEWERS OCCUPANT OF STORM SEWERS OF STORM SEWERS OCCUPANT OF STORM SEWERS OF STORM SEW
- 9. STORM AND SANTARY PDC'S SHALL BE LAD AT MINIMUM CRADE (0.5% STORM, 2.0% SANTARY) UNLESS RECOMMENDED DEPTHS ARE EXCEEDED ON A SPACE COUNCIL'S MULL RESULT. DECARDINGS FROM MINIMUM CONCENTRY THE APPROACH BY THE EMPIRETY PDC LOCATIONS TO MEDITE. ALL PROVIDED PARK DECARDING (PDCS) ARE TO COMMENT OF MEDITE ALL PROVIDED PARK DECARDING (PDCS) ARE TO COMMENT OF MEDITE ALL PROVIDED PARK DECARDING (PDCS) ARE TO COMMENT OF MEDITE ALL PROVIDED PARK SHOWN IN WHERE BY IS NOT POSSIBLE, LONG RADIUS 250 BEINGS AND LONG RADIUS 220° BEINGS MULL BE FERMITED, BOTT OF THE STORM PDGS AND CATCHEAST LESS. OF MY APPER BELLS OF RADIUS TEST. THE CONTRACTOR SHALL BETALL OF LONG-TO-SIGNED THE COMMENTER WITH STORM PDGS AND CATCHEAST LESS. OF MY APPER BELLS OF RADIOS TEST. THE CONTRACTOR SHALL BETALL OF LONG-TO-SIGNED THE COMMENTER WITH STORM PACKET OF THE PARK THE ADMINISTRATION OF THE COMMENT OF THE PARK THE
- THE CONTRACTOR SHALL BE RESPONSEDE FOR MANTANING WHER SERVER AT ALL TIMES. ALL WATERMAN MAST BE PAY OR 18. ALL
 WATERMAN MAYER MAST BE OFFICIAL BY WAINDS-MAY FOR CONTRACT. ALL WATERMAN MAST BE POW, FOR THE PAY F
- 11. MANUAU PRINSIBLE JOST DETLECTION ON PUE PER SALL BE 2.9 (G.72P PER S.III. LEUGHT) FOR SOMME PER AND 1.0 (G.72P PER S.III. LEUGHT) FOR SOMME PER AND 1.0 (G.72P PER S.III. LEUGHT) FOR SOMME PER AND 1.0 (G.72P PER S.III. LEUGHT) FOR SOMME PER AND 1.0 (G.72P PER S.III. LEUGHT) FOR SOMME PER AND 1.0 (G.72P PER S.III. LEUGHT) FOR SOMME PER AND 1.0 (G.72P PER S.III. LEUGHT) FOR SOMME PER SECONDATION OF THE PERSONNE FOR SECONDATION OF THE PERSONN
- 12. THE CONTRACTOR WILL BE REQUIRED TO PLACE STYROFOAM HIGH LOAD INSULATION OVER SHALLOW WATERMAINS AND/OR ADJACENT TO CULVERTS/STORM SEWERS/CATCHBASINS AS NOTED IN PROFILE OR AS DIRECTED ON SITE.
- 13. THE DEVELOPER WILL INSTALL 'T-RAIL' STEEL FENCE POSTS AT ALL PROPERTY BARS, TO BE LOCATED 150MM ON LOT SIDE OF BARS WITH 'POINTING TO BAR. THE CONTRACTOR MUST NOT DISTURB THIS CONTROL.
- 14. THE CONTRACTOR SHALL PERMIT REASONABLE ACCESS AFTER SEWERS AND WATERMAIN AND BEFORE ROADBASE FOR UTILITY ROAD CROSSINGS IF REQUESTED. GAS LINES MUST BE SUPPORTED IN ACCORDANCE WITH ENBRIDGE GAS SPECIFICATIONS FOR GAS LINE SUPPORTS.
- THE CONTRACTOR SHALL SHORE EXCAVATIONS AS REQUIRED TO PREVENT DAMAGE TO EXISTING OR FUTURE PAYAMENT/UTILITIES/STRUCTURES/TREES/ETC. TRACKING OF GLEATED EQUIPMENT IS NOT PREMITTED ON PAYED SURFACES THAT ARE TO REMAIN. CARELESS DAMAGE TO APEC APEC SHALL BE REPAIRED BY CONTRACTOR AT NO EXPENSE TO OWNER.
- 16. SEDMENT LOADING MUST BE WINIMZED AT ALL TIMES BY PLACING PILTER COTH UNDER ALL MAHFOLE COVERS AND CATCHBASH GRATES. SLL PERCESS SHALL BE PLACED (WITH STRAW BALES, IF PROJECTS) ACKNOS DRAWAGE SWALES, AND CATCHBASHS, DITCH INLETS AND PROJECT IS ACCEPTED. THE CONTRACTOR SHALL BROWNES SLIT PRINCES MONOR STRAW BALES AS DIRECTED UPON ACCEPTANCE. ANY SLL PRITERIOR ABUTTING RAWER WATER COURSE SHALL BE REMOVED AT NO ADDITIONAL COST TO THIS PROJECT.
- 17. THE CONTRACTOR MUST GRAWN THE DIMENSEYS APPROVE FOR EACH PREPARED SHEPPER ESPECIES PROCESSION WITH SUBSCILLENT ROPK, LIS SHEPPER GRANALARY BY CIT. THE TREVIOLES SHALL BE REASTLEED AND COMPATTER IN ACCORDANCE WITH ORSE OF MAN DOSS INSECTIONS SHALL BE COMPACTED TO 95% PROCEDUR. IT IS ANTICHATED THAT CURB AND CUTTER, SCEWALK AND HOT-MAY ASPHALT WILL BE INSTALLED IN THE SPRING OF 9223. THE SERVICES CONTRACTOR WILL BE RESPONSED FOR OFFICE AND STETLED SERVICE AND MET AND ADMINISTRATION OF THE SERVICES OFFICE AND STETLED AND STETLE
- 18. ELEVATIVE: SHOWN ME IT PRINSED GRADE. PASS RADAWS TO SUPERACE AND MEDI BULLIANDS TO PRINSED GRADE WITH NATION OF CAME COMPACT COMPACT.

 NOTIFICATION COMPACT TO COMPACT CO
- 15. EART BALLACE, MAY BE ACHINED BY MODERANIC ON DECISIONING BUILDINGS WITHING ON LOT SEE AS DIRECTION ON STE. ALL SLOSES SHALL BE 21 MAXIMUM FOR EASY MAINTENANCE. ALL FLIL GOMERATOR BY PER DIRECLASHOPH MUST BE USED TO RADE GONDONING SHADE. AND CONTINUED BOULEVARDS. IF INCESSARY FOR MATERIAL BALANCE, BOULEVARDS CAN BE KEPT 0.1±m BELOW DESIGN GRADE.
- 20. RESTORATION SHALL BE INCLUDED IN PIPE PRICES. ETC. UNLESS OTHERWISE NOTED IN FORM OF TENDER.
- 21. PAVEMENT AND CONCRETE REMOVED SHALL BE SAWCUT/MILLED FULL DEPTH ADJACENT TO AREAS TO REMAIN IN PLACE. LIMITS AS DIRECTED BY THE ENGINEER AT TIME OF CONSTRUCTION. SAWCUT AND MILL LAP JOINT ON BOTH SIDES OF ROAD CROSSINGS.
- 22. TREES INJURED DURING CONSTRUCTION SHALL BE TRIMMED AND MAJOR CUTS SEALED. TAKE PRECAUTION TO AVOID DAMAGE TO TREES TO REMAIN, PLACE TEMPORARY SNOW FENCE AS DIRECTED.
- 23. SITE ACCESS MUST BE VIA CONSTRUCTION ACCESS ROAD FROM SOUTHDALE LINE.
- 24. THE CONTRACTOR SHALL CONTROL DUST THROUGHOUT THE PROJECT DURATION USING EITHER CALCIUM, WATER, OR SWEEPING AS DIRECTED BY THE ENGINEER.






	REVISION		
4	REISSUED FOR CONSTRUCTION	12 SEPT 2023	DJL
3	ISSUED FOR CONSTRUCTION	26 JAN 2023	DJL
2	ISSUED FOR TENDER	5 DEC 2022	DJI
1	ISSUED FOR MECP APPLICATION	25 NOV 2022	DJL
	DESCRIPTION	DD/MM/YYYY	BY


CONTRACT #:	19012	SCALE:	AS SHOWN
PROJECT NAME:	EAGLE RIDGE SUBDIVISION PHASE 2 - RP 11M-263 DOUG TARRY LIMITED	DRAWING	#: 15


GENERAL NOTES

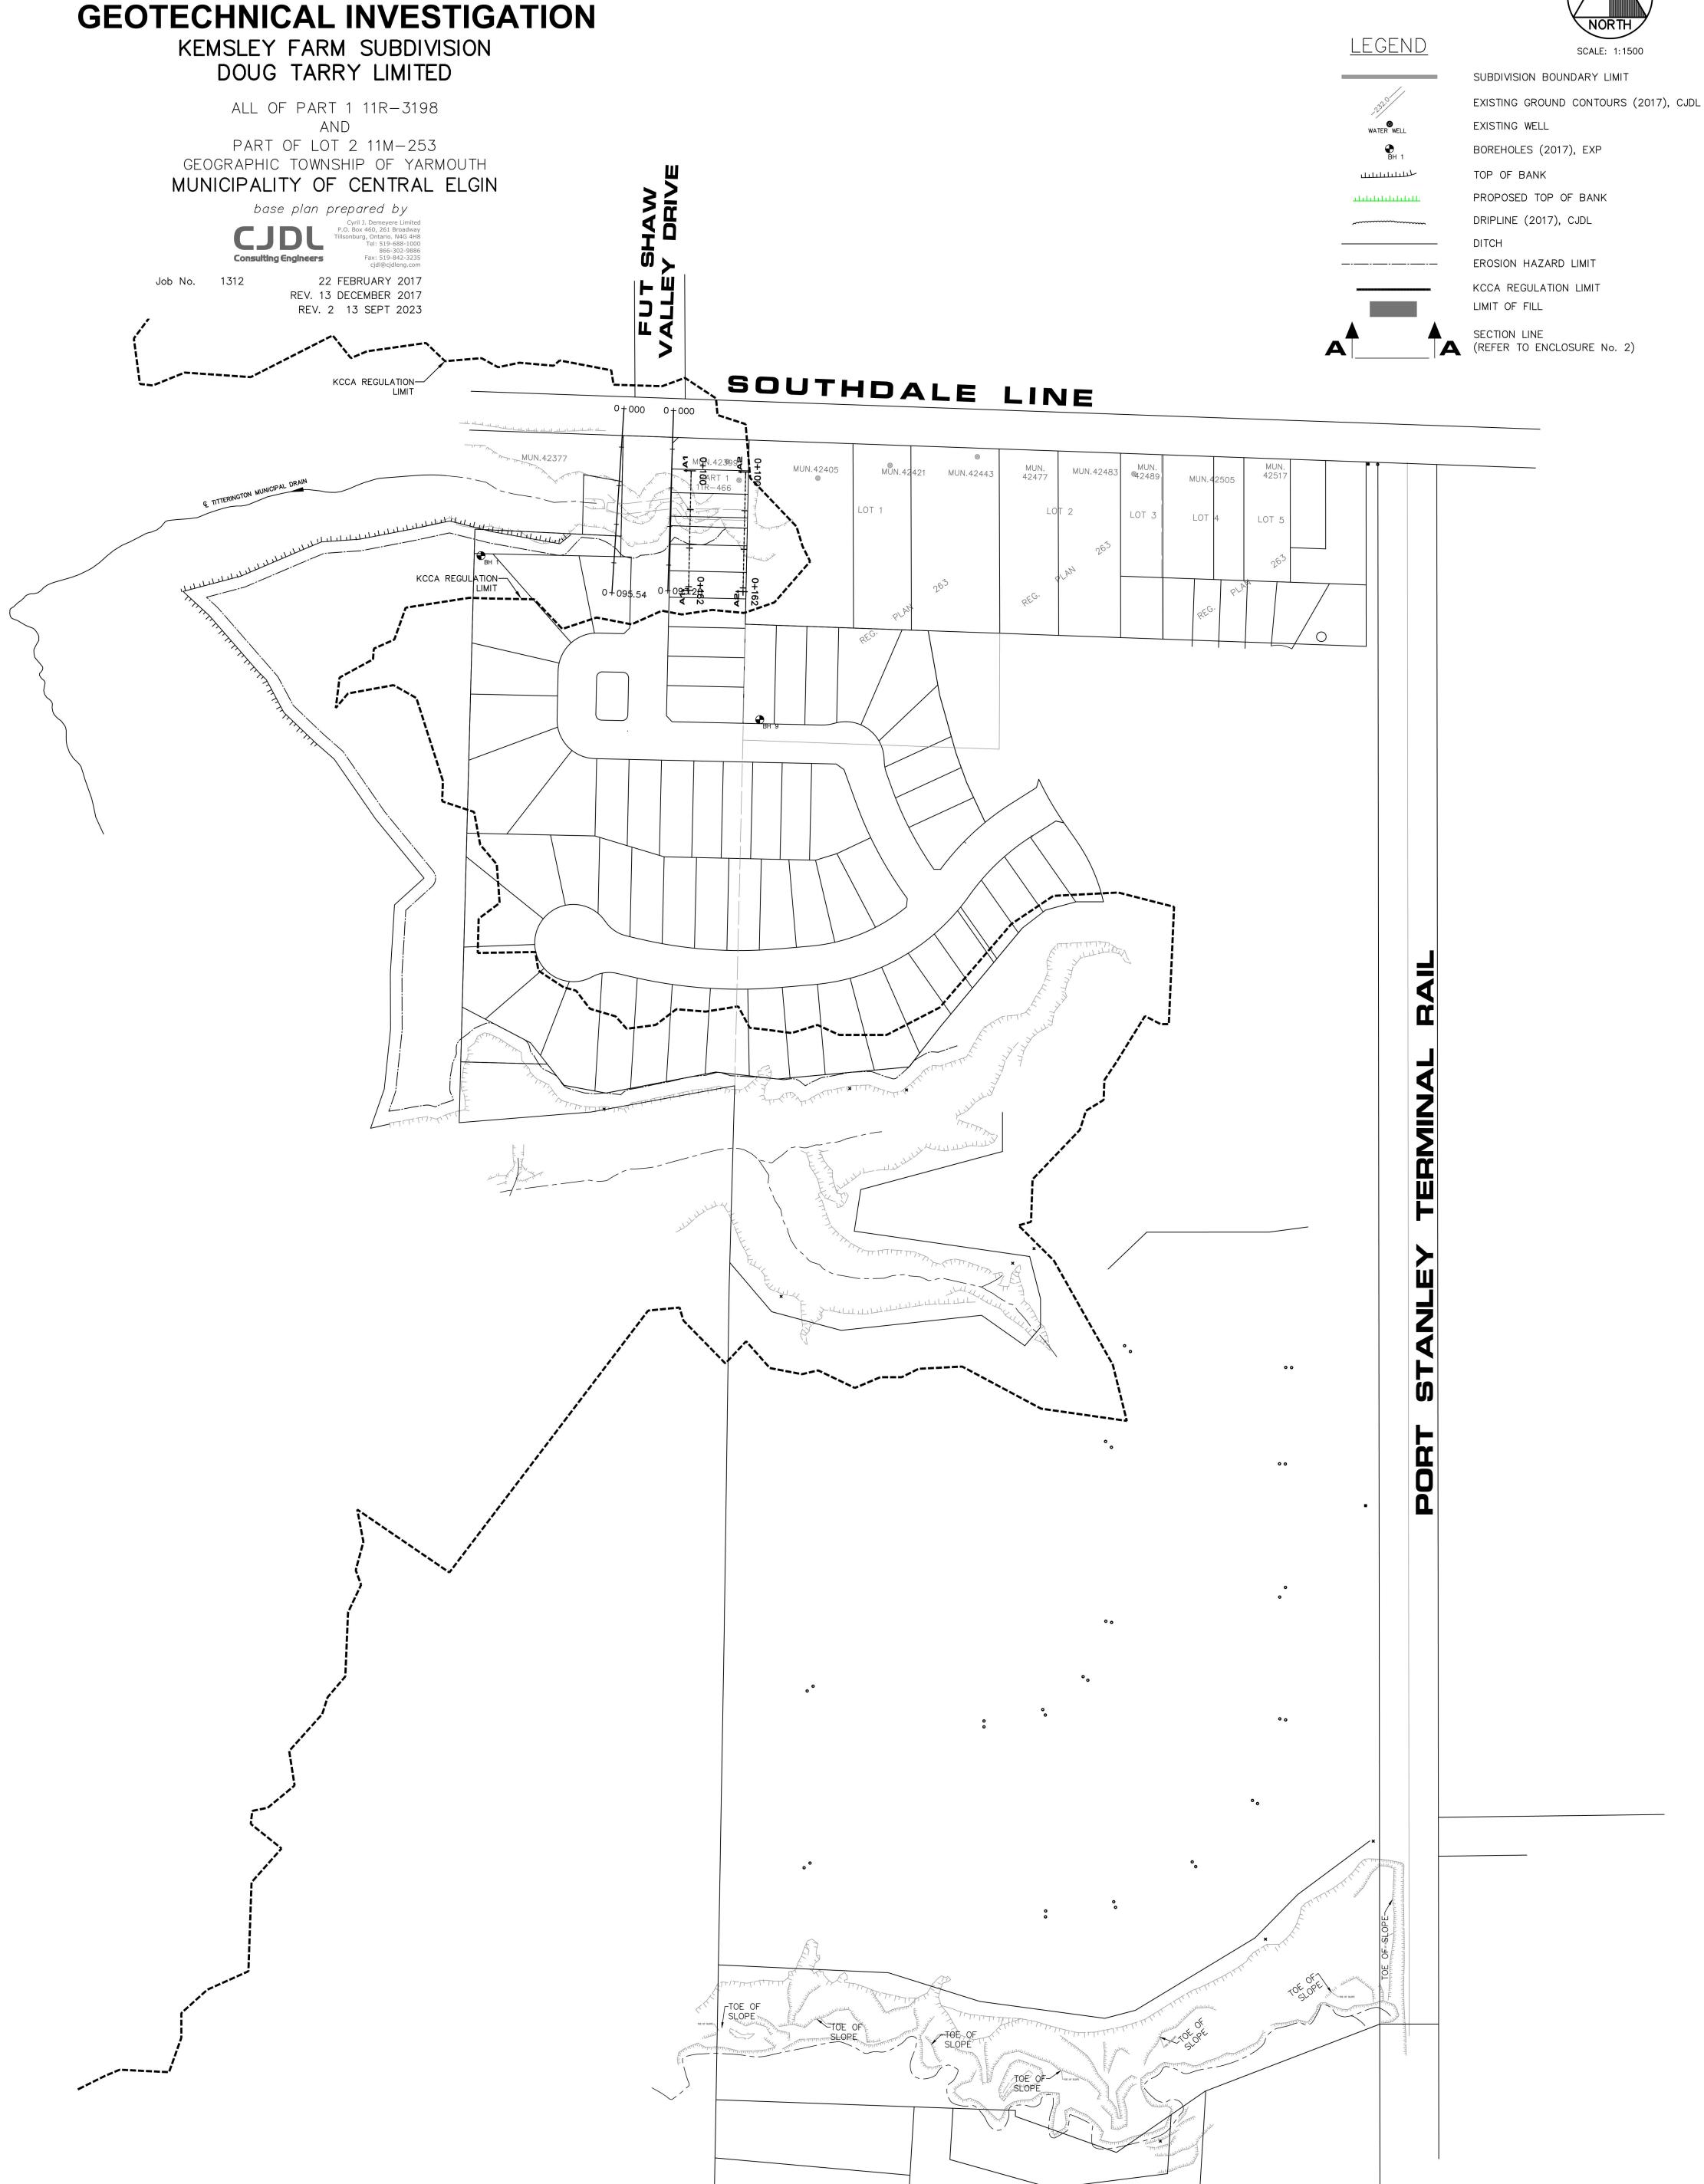



GEOTECHNICAL INVESTIGATION KEMSLEY FARM SUBDIVISION DOUG TARRY LIMITED


ALL OF PART 1 11R-3198 AND PART OF LOT 2 11M-253 GEOGRAPHIC TOWNSHIP OF YARMOUTH MUNICIPALITY OF CENTRAL ELGIN

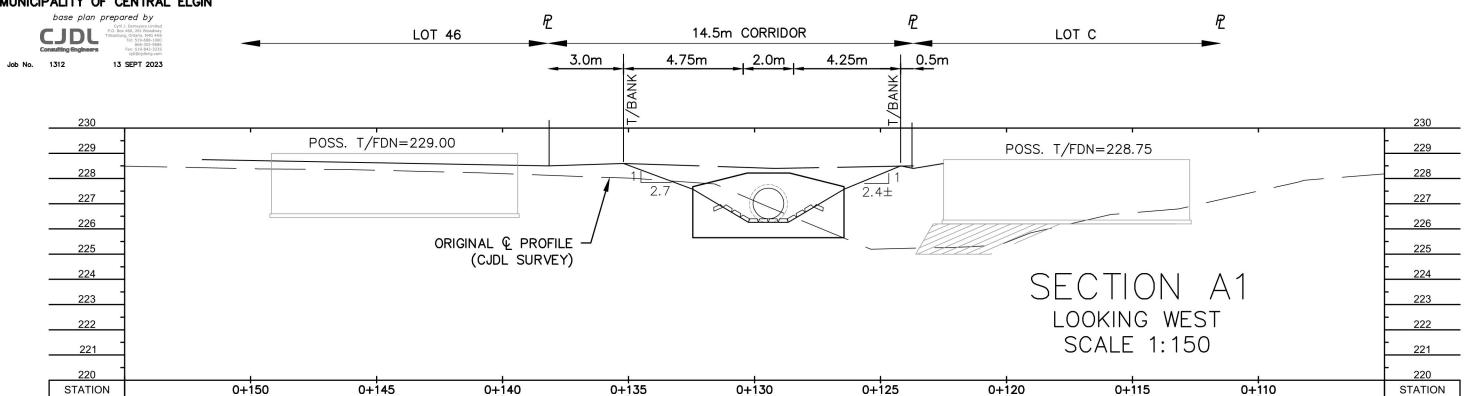

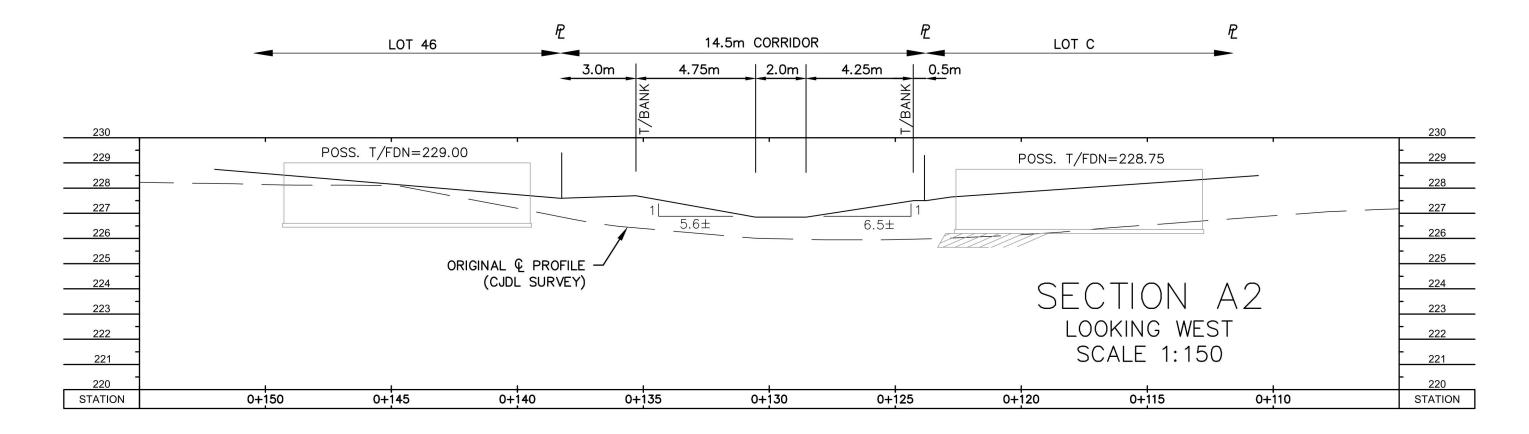

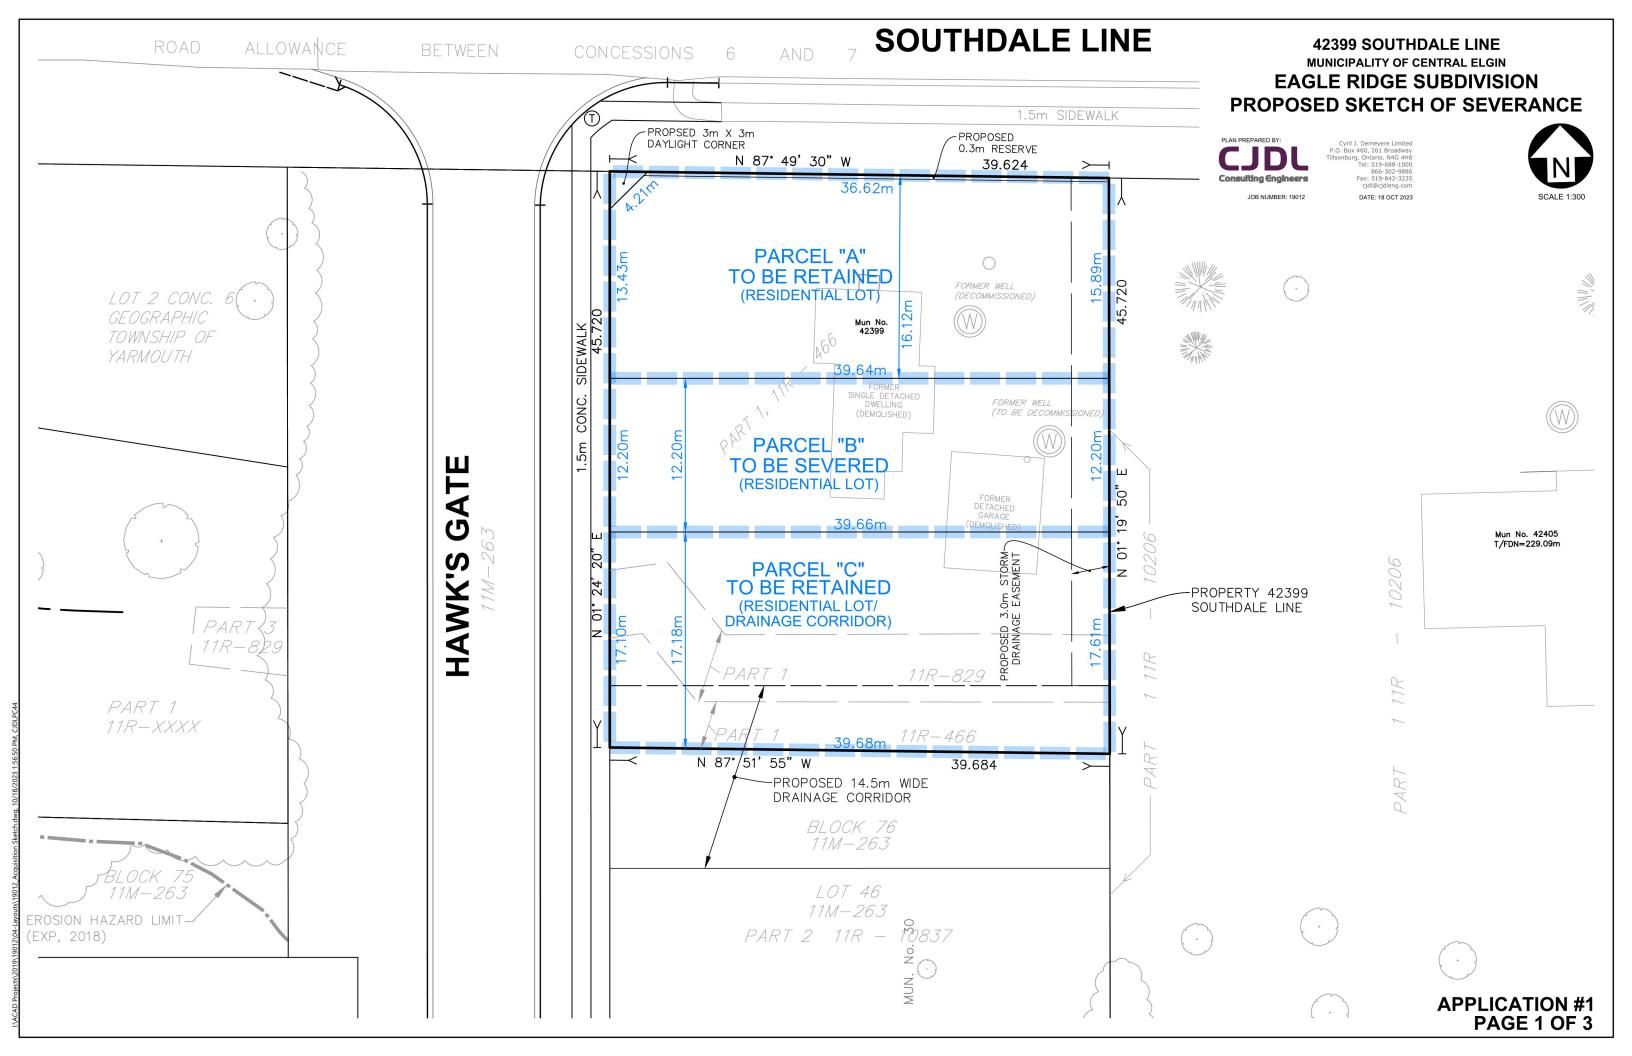

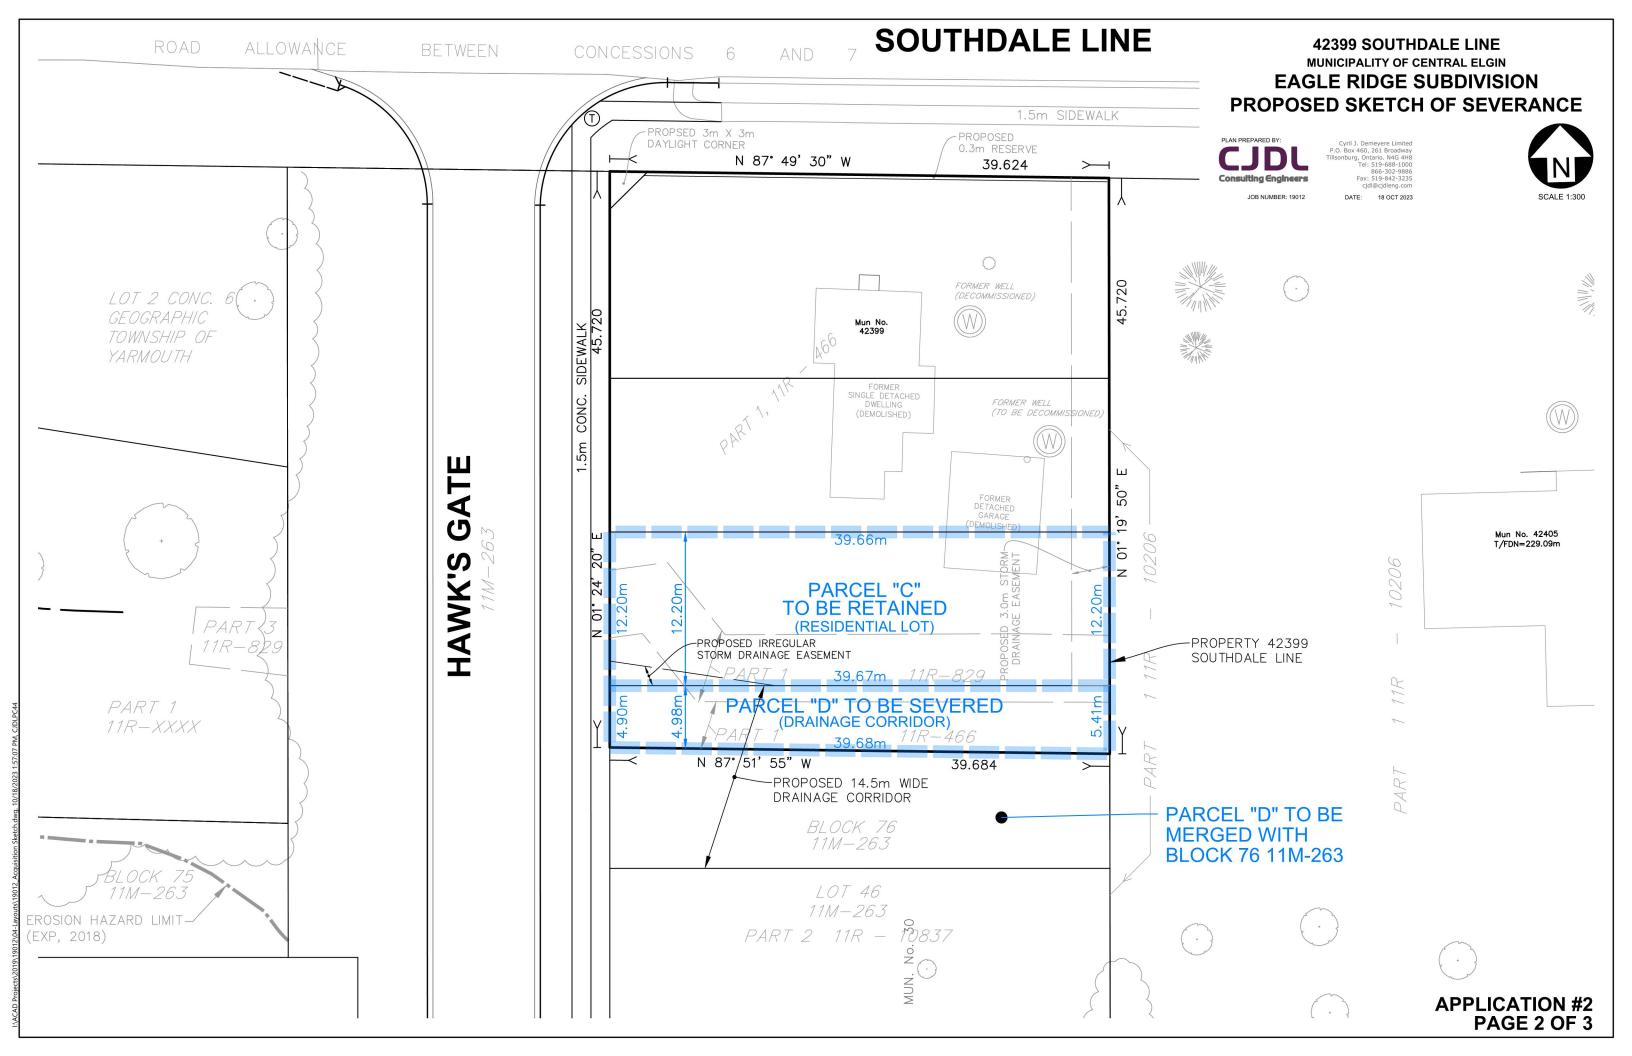

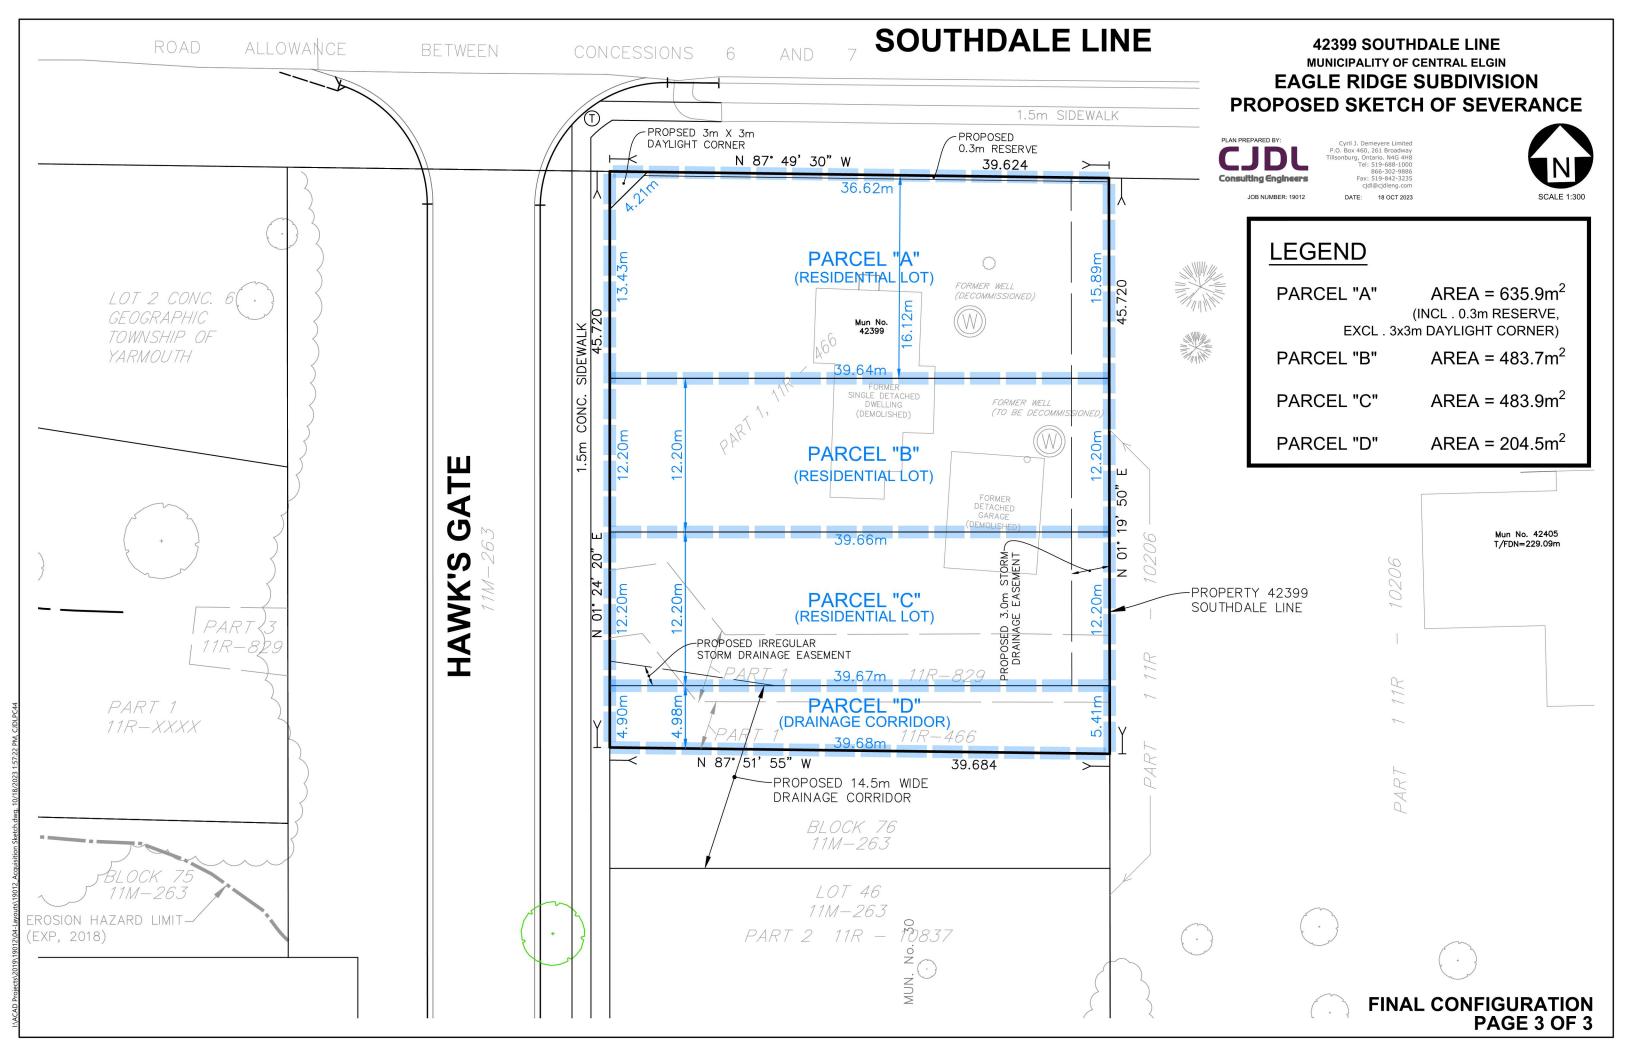



CJDL - Deren Lyle

IN-PLACE DENSITY MEASUREMENTS

EXP Services Inc.

15701 Robin's Hill Road 405 Maple Grove Rd., Unit 6 Cambridge, ON N3E 1B6 tel: 519.963.3000 tel: 519.650.4918 fax: 519.963.1152 fax: 519.650.4603

2199 Blackacre Drive, Unit 600 Oldcastle (Windsor), ON NOR 1L0 tel: 519.737.0588 fax: 519.737.0751 265 Front Street North, Suite 411G Sarnia, ON N7T 7X1 tel: 519.332.1550 fax: 519.332.5662

Project No.:	Project No.: LON-23002025-A0 100					eport No.:	2023-8	
Project Name: Eagle Ridge Subdivision - Phase 2, Central Elgin, ON						ate Tested:	Sep 11, 2023	
Project Location: Southdale Line						ontractor:	Titan	
	Central	Elgin, ON						
Additional Sit	e Information	n:						
Compaction Equipment:	Sheepsfoo	t roller			W	/eather:	Clear	
Location	Road fill ne	ear MH ST18, Hawks Gate			T	emperature:	20	_°C
of Testing:					L	ift Thickness:	300	mm
Type (Material / Soil Description	Optimum Moisture Content (%)	Refer Den (kg,	sity /m³)	Source of Reference Density	Specified Compaction Level (%)	Test Results (pass/fail)
Engineered F	ill	Silty clay	15.0	1870	-	Field Proctor	98	Pass
							-	
Comments: Nuclear results are considered as approximate measurements of insitu density conditions at the test elevation and location indicate Results based on estimated reference densities are subject to change after actual laboratory density values are obtained. Asphalt densities by nuclear gauge may be higher or lower than the actual density determined by asphalt cores. Itest Results Generally Meet Specification Preliminary Report left on site with Test Results Generally Below Specification Soil Moisture Content Requires Adjustments Additional Compaction Recommended Asphalt Flushing/Bleeding Noted Asphalt Surface Segregation/Cracking Noted Additional Notes: Contact EXP for Retesting						phalt ATION ts		
Report Distrib 2561603 Onta CJDL - Jeff Vi CJDL - Came	ario Ltd Za ckers	j	zrachar@cjdler vickers@cjdler ccluett@cjdleng	ig.com			Site Inspe	

dlyle@cjdleng.com

D. Speller, P. Eng.
EXP Services Inc.
Geotechnical Division



EXP Services Inc.

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Project Name:

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265 Front Street North, Suite 411G Sarnia, ON N7T 7X1 tel: 519.332.1550 fax: 519.332.5662

Sep 11, 2023

LON-23002025-A0 100 Project No.:

Eagle Ridge Subdivision - Phase 2, Central Elgin, ON

Project Location: Southdale Line

Central Elgin, ON

2023-8 Report No.:

Contractor: Titan

Date Tested:

Test Test Location and Depth Material Description **Test Results** Comments No. 5m east of ST 18 1 Approximate elevation 227.90m Silty clay **Pass** 10m east of ST 18 2 Approximate elevation 227.90m Silty clay Pass 98 % SPMDD **Compaction Required:** Silty clay Comments

Test locations referenced from specified manhole

Test elevations reference: Geodetic



CJDL - Deren Lyle

IN-PLACE DENSITY MEASUREMENTS

EXP Services Inc.

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2199 Blackacre Drive, Unit 600 Oldcastle (Windsor), ON NOR 1L0 tel: 519.737.0588 fax: 519.737.0751 265 Front Street North, Suite 411G Sarnia, ON N7T 7X1 tel: 519.332.1550 fax: 519.332.5662

LON-23002025-A0 100 2023-9 Project No.: Report No.: **Project Name:** Eagle Ridge Subdivision - Phase 2, Central Elgin, ON Sep 12, 2023 **Date Tested:** Project Location: Southdale Line Contractor: Titan Central Elgin, ON Additional Site Information: Weather: Cloudy Sheepsfoot roller Compaction **Equipment:** 20 °C Temperature: Location Road fill near MH ST18. Hawks Gate of Testina: Lift Thickness: 300 mm Reference **Optimum** Source of Specified Test Type of Material / Density Moisture Reference Compaction Results **Material Tested** Soil Description (kg/m³) Content (%) (pass/fail) Density Level (%) **Engineered Fill** Silty clay 15.0 1870 Field Proctor 98 **Pass** Comments: Nuclear results are considered as approximate measurements of insitu density conditions at the test elevation and location indicated. Results based on estimated reference densities are subject to change after actual laboratory density values are obtained. Asphalt densities by nuclear gauge may be higher or lower than the actual density determined by asphalt cores. X VARIABLE TEST RESULTS - AT & BELOW SPECIFICATION TEST RESULTS GENERALLY MEET SPECIFICATION TEST RESULTS GENERALLY BELOW SPECIFICATION Preliminary Report left on site with Soil Moisture Content Requires Adjustments Additional Compaction Recommended Sample(s) Obtained for Laboratory Analysis Asphalt Flushing/Bleeding Noted Number of Samples: Asphalt Surface Segregation/Cracking Noted **Additional Notes:** Contact EXP for Retesting Report Distribution: Site Inspector: 2561603 Ontario Ltd. - Zachary Rachar zrachar@cjdleng.com CJDL - Jeff Vickers jvickers@cjdleng.com J. Guenther CJDL - Cameron Cluett ccluett@cidleng.com

dlyle@cjdleng.com

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Geotechnical Division



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Project Name:

405 Maple Grove Rd., Unit 6 Cambridge, ON N3E 1B6 tel: 519.650.4918 fax: 519.650.4603 2199 Blackacre Drive, Unit 600 Oldcastle (Windsor), ON NOR 1L0 tel: 519.737.0588 fax: 519.737.0751

265 Front Street North, Suite 411G Sarnia, ON N7T 7X1 tel: 519.332.1550 fax: 519.332.5662

Project No.: LON-23002025-A0 100

Eagle Ridge Subdivision - Phase 2, Central Elgin, ON

Project Location: Southdale Line

Central Elgin, ON

Report No.: 2023-9

Date Tested: Sep 12, 2023

Contractor: Titan

Test No.	Test Location and De	epth	Material Description	Test Results	Comments
1	5m east of ST 18 Approximate elevation	on 228.90m	Silty clay	Pass	
2	15m east of ST 18 Approximate elevation	on 229.00m	Silty clay	Pass	
3	25m east of ST 18 Approximate elevation	on 229.00m	Silty clay	Pass	
4	35m east of ST 18 Approximate elevation	on 229.3m	Silty clay	Pass	
5	45m east of ST 18 Approximate elevation	on 229.30m	Silty clay	Pass	
لــــا		I		la a	
Com	paction Required:	Silty clay		98	% SPMDD
Comi	ments				

Test locations referenced from specified manhole

Test elevations reference: Geodetic



EXP Services Inc.

15701 Robin's Hill Road London, ON N5V 0A5 tel: 519.963.3000 fax: 519.963.1152

CJDL - Deren Lyle

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Project No.:	LON-23	LON-23002025-A0 100				eport No.:	2023-13	
Project Name:	ect Name: Eagle Ridge Subdivision - Phase 2, Central Elgin, ON					ate Tested:	Sep 13, 2023	
The state of the s						ontractor:	Titan	
	Central	Elgin, ON						
Additional Site I							_	
Compaction S Equipment:	Sheepsfoo	t roller, hoe pack.			W	leather:	Sunny	
Water and the second second	SA 83 - Ex	isting SAN on Southdale Line.			Т	emperature:	19	_°C
of Testing:					L	ift Thickness:	300	mm
			Optimum	Refer	ence	Source of	Specified	Test
Type of		Material /	Moisture	Den		Reference	Compaction	Results
Material Te	sted	Soil Description	Content (%)	(kg/ Opt. / Sto	m ³) one Corr.	Density	Level (%)	(pass/fail)
Trench Backfill		Silty Clay	13.0	1885		Laboratory	95	Pass
Road Subbase		Granular B	6.1	2290		Laboratory	100	Pass
Re	sults based	are considered as approximate meas on estimated reference densities are clear gauge may be higher or lower the	subject to change a	fter actual	laborato	ry density values		
X Test Resu	LTS GENER	ALLY MEET SPECIFICATION	□ v	ARIABLE .	Test Re	SULTS - AT &	BELOW SPECIFIC	ATION
☐ Preliminary	Report lef	t on site with	□ т	EST R ESU	ILTS G E	NERALLY BELO	w Specification	
				Soil	Moistur	e Content Req	uires Adjustmen	ts
Sample(s)	Obtained f	or Laboratory Analysis		Add	itional C	compaction Re	commended	
		,,		Asp	halt Flus	shing/Bleeding	Noted	
Number of				Asp	halt Sur	face Segregati	on/Cracking Not	ed
Additional Notes	s:			Con	tact EXF	of for Retesting		
Report Distributi							.	
2561603 Ontario		•	zrachar@cjdler	-			Site Inspe	
CJDL - Jeff Vicke			jvickers@cjdler	=			E. McWh	nirter
CJDL - Cameron Cluett ccluett@cjdleng.com								

dlyle@cjdleng.com

D. Speller, P. Eng. EXP Services Inc.

Geotechnical Division



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265 Front Street North, Suite 411G Sarnia, ON N7T 7X1 tel: 519.332.1550 fax: 519.332.5662

Project No.: LON-23002025-A0 100

Report No.:

2023-13

Titan

Project Name: Eagle Ridge Subdivision - Phase 2, Central Elgin, ON

Date Tested:

Sep 13, 2023

Project Location: Southdale Line

Contractor:

Central Elgin, ON

Test No.	Test Location and De	epth	Material Description	Test Results	Comments
1	4 m south, 1 m west 2 m below top of sub		Silty Clay	Pass	
2	3 m south, 1 m east 2 m below top of sub		Silty Clay	Pass	
3	8 m north of SA 83 1.5 m below top of se	ubgrade	Silty Clay	Pass	
4	15 m north of SA 83 1.0 m below top of so		Silty Clay	Pass	
5	Southdale Line, wes 2 m south of existing Top of granular base	SAN.	Granular B	Pass	
Com	paction Required:	Silty Clay		95	% SPMDD
		Granular B		100	% SPMDD
Com	ments				

Slight deflection, no rutting in silty clay material. Area south of SA 83 was repacked and retested.



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Project No.:	Project No.: LON-23002025-A0 100					eport No.:	2023-10	
Project Name: Eagle Ridge Subdivision - Phase 2, Central Elgin, ON					D	ate Tested:	Sep 19, 2023	
Project Location: Southdale Line Central Elgin, ON						ontractor:	Titan	
Additional Site	Information	n:						
Compaction Equipment:	Sheepsfoo	ot roller			W	leather:	Clear	
Location of Testing:	Road fill ne	ear SAMH 83, Hawks Gate			T	emperature:	20	_°C
or resung.					Li	ft Thickness:	300	mm
Type o Material T		Material / Soil Description	Optimum Moisture Content (%)	Refer Der (kg.	nsity /m³)	Source of Reference Density	Specified Compaction Level (%)	Test Results (pass/fail)
Road Fill		Silty Clay	13.0	1885	1888	Laboratory	98	Pass
				200				
F	Results based	s are considered as approximate measu on estimated reference densities are su uclear gauge may be higher or lower tha	ibject to change a	fter actua	laborato	ry density values		
X TEST RES	SULTS GENER	RALLY MEET SPECIFICATION	□ V	ARIABLE	Test Re	SULTS - AT & I	BELOW SPECIFIC	ATION
☐ Prelimina	ıry Report let	ft on site with	□т	EST R ESI	JLTS G EI	NERALLY BELOW	N SPECIFICATION	
				Soil	Moistur	e Content Requ	uires Adjustmen	ts
	- \ O -1-'	for Laborations Assolved		Add	litional C	ompaction Red	commended	
Sample(s) Obtained i	for Laboratory Analysis		Asp	halt Flus	shing/Bleeding	Noted	
Number	of Samples:		Asphalt Surface Segregation/Cracking Noted					
Additional Not	es:			☐ Con	tact EXF	for Retesting		
Report Distribu	ution:							
2561603 Ontar	rio Ltd Za	chary Rachar z	zrachar@cjdleng.com			Site Inspe	ector:	
CJDL - Jeff Vic		•	rickers@cjdler	•			J. Guen	ther
CJDL - Camero			cluett@cjdlen@					
CJDL - Deren I	Lyle	d	lyle@cjdleng.d	com				

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Geotechnical Division



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Project Name:

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265 Front Street North, Suite 411G Sarnia, ON N7T 7X1 tel: 519.332.1550 fax: 519.332.5662

Sep 19, 2023

LON-23002025-A0 100 Project No.:

Eagle Ridge Subdivision - Phase 2, Central Elgin, ON

Project Location: Southdale Line

Central Elgin, ON

2023-10 Report No.:

Contractor: Titan

Date Tested:

Test No.	Test Location and De	epth	Material Description	Test Results	Comments
1	8 m S, 2 m W 0.6 m below subgrad	de	Silty Clay	Pass	
2	8 m S, 2 m E 0.6 m below subgrad	de	Silty Clay	Pass	
3	8 m S, 6 m E 0.6 m below subgrad	de	Silty Clay	Pass	
4	8 m S, 2 m W At subgrade		Silty Clay	Pass	
5	8 m S, 3 m E At subgrade		Silty Clay	Pass	
6	8 m S, 6 m E At subgrade		Silty Clay	Pass	
Com	paction Required:	Silty Clay	•	98	% SPMDD
Com	ments				

All tests referenced from SAMH 83.





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Project No.: LON-23002025-A0 Project Name: Eagle Ridge Subdivision - Phase 2, Central Elgin, ON

2561603 Ontario Ltd Zachary Rachar	Site: Southdale Line		
c/o Cyril J. Demeyere Limited	Central Elgin, ON		
261 Broadway Street	Report Number:	2023-7	
PO Box 460	Date of Visit:	Sep 20, 2023	3
Tillsonburg, ON	Time of Visit:	AM	
N4G 4H8	Weather:	Overcast	13 °C

Subgrade Examination - Lot C, Hawks Gate

As requested, EXP visited the above site to observe the subgrade soil conditions at the above-mentioned location, prior to engineer fill placement.

EXP observed that the contractor had excavated the previous fill material and removed the previous drain. The exposed soil was found to be a native grey silty clay till observed at approximately 223.06 m. The north bank of excavation is native and does not require expanding the excavation in that direction. The excavation was expanded on all other sides to accommodate suitable engineered fill geometry. Fill material will be imported and will be a fine sand.

As determined by hand probing in visual observation, the area is considered suitable for the placement of engineered fill.

EXP will return to monitor progress.

Technician: J. Guenther

Distribution:

2561603 Ontario Ltd. - Zachary Rachar

CJDL - Jeff Vickers

CJDL - Cameron Cluett

CJDL - Deren Lyle

zrachar@cjdleng.com jvickers@cjdleng.com ccluett@cjdleng.com dlyle@cjdleng.com

D. Speller, P. Eng.

exp Services Inc.Geotechnical Division



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Project No.: LON-23002025-A0 100			Re	eport No.:	2023-12			
Project Name: Eagle Ridge Subdivision - Phase 2, Central Elgin, ON			Da	ate Tested:	Sep 20, 2023			
Project Location: Southdale Line			Co	ontractor:	Titan			
Central	Elgin, ON							
Additional Site Informatio	n:							
Compaction Sheepsfoo	ot roller			W	eather:	Clear		
Equipment:				T	emperature:	20	°C	
Location Lot C, Have of Testing:	vks Gate			16	inperature	20	_ `	
or resumg.				Li	ft Thickness:	300	mm	
					.=			
Tuno of	Motorial /	Optimum	Refere	1160,000	Source of	Specified	Test	
Type of Material Tested	Material / Soil Description	Moisture	Dens	-	Reference	Compaction	Results	
Waterial Feeted	Con Bocomption	Content (%)	(kg/n Opt. / Stone	n) e Corr.	Density	Level (%)	(pass/fail)	
Engineered Fill	Silty fine sand	14.0	1780	=	Field Proctor	100	Pass	
Results based	s are considered as approximate mea on estimated reference densities are uclear gauge may be higher or lower	subject to change a	fter actual la	aborator	y density values			
	RALLY MEET SPECIFICATION		•			BELOW SPECIFIC	ATION	
		□т	EST RESUL	TS GEN	IERALLY BELOV	SPECIFICATION		
☐ Preliminary Report left on site with ☐ TEST RESULTS GENERALLY BELOW SPECIFICATION ☐ Soil Moisture Content Requires Adjustments								
			_			-	13	
Sample(s) Obtained for Laboratory Analysis			Additional Compaction RecommendedAsphalt Flushing/Bleeding Noted					
Number of Samples:	Asphalt Surface Segregation/Cracking Noted							
Additional Notes:	Contact EXP for Retesting							
					J			
Report Distribution:		_				0''		
2561603 Ontario Ltd Za	zrachar@cjdleng.com Site Inspector:							
CJDL - Jeff Vickers jvickers@cjd CJDL - Cameron Cluett ccluett@cjdle			-			J. Guen	tner	
CJDL - Cameron Cluett CJDL - Deren Lyle		ccluett@cjdleng.dlyle@cjdleng.d						
		,						

D. Speller, P. Eng.
EXP Services Inc.
Geotechnical Division



Project Name:

IN-PLACE DENSITY MEASUREMENTS

EXP Services Inc.

15701 Robin's Hill Road 405 London, ON N5V 0A5 Car tel: 519.963.3000 tel: fax: 519.963.1152 fax:

405 Maple Grove Rd., Unit 6 Cambridge, ON N3E 1B6 tel: 519.650.4918 fax: 519.650.4603 2199 Blackacre Drive, Unit 600 Oldcastle (Windsor), ON NOR 1L0 tel: 519.737.0588 fax: 519.737.0751

265 Front Street North, Suite 411G Sarnia, ON N7T 7X1 tel: 519.332.1550 fax: 519.332.5662

Project No.: LON-23002025-A0 100

Eagle Ridge Subdivision - Phase 2, Central Elgin, ON

Project Location: Southdale Line

Central Elgin, ON

Report No.: 2023-12

Date Tested: Sep 20, 2023

Contractor: Titan

Test No.	Test Location and De	epth	Material Description	Test Results	Comments
1	Front 1.0m below		Silty fine sand	Pass	
2	Rear 0.7m below		Silty fine sand	Pass	
3	Front at top of engineered fill				
4	Centre 0.3m below		Silty fine sand	Pass	
Compaction Required: Silty fine sand			100	% SPMDD	
Comi	ments				

Test locations referenced from specified area of building footprint

Test elevations referenced from top of engineered fill (150mm above proposed underside of footing)



EXP Services Inc.

15701 Robin's Hill Road London, ON N5V 0A5 tel: 519.963.3000 fax: 519.963.1152 405 Maple Grove Rd., Unit 6 Cambridge, ON N3E 1B6 tel: 519.650.4918 fax: 519.650.4603 2199 Blackacre Drive, Unit 600 Oldcastle (Windsor), ON NOR 1L0 tel: 519.737.0588 fax: 519.737.0751 265 Front Street North, Suite 411G Sarnia, ON N7T 7X1 tel: 519.332.1550 fax: 519.332.5662

Project No.: LON-23002025-A0 100			R	Report No.: 2023-11					
Project Name: Eagle Ridge Subdivision - Phase 2, Central Elgin, ON					D	ate Tested:	Sep 21, 2023		
Project Location: Southdale Line Central Elgin, ON						ontractor:	Titan		
Additional Site	e Information Sheepsfoo				w	eather:	Clear		
Location Road III Hear Will SAGS, Hawks Cate					Т	emperature:	20	_°C	
of Testing:					Li	ift Thickness:	300	mm	
Type o		Material / Soil Description	Optimum Moisture Content (%)	Der	rence nsity /m³) one Corr.	Source of Reference Density	Specified Compaction Level (%)	Test Results (pass/fail)	
Road Base		Silty clay	13.0	1885	1888	Laboratory	98	Pass	
	Comments: Nuclear results are considered as approximate measurements of insitu density conditions at the test elevation and location indicated. Results based on estimated reference densities are subject to change after actual laboratory density values are obtained. Asphalt densities by nuclear gauge may be higher or lower than the actual density determined by asphalt cores.								
	-	RALLY MEET SPECIFICATION	_		-	2	BELOW SPECIFIC	CATION	
Preliminary Report left on site with			☐ Test Results Generally Below Specification						
	,						uires Adjustmen		
_				_			-	10	
Sample((s) Obtained	for Laboratory Analysis	Additional Compaction RecommendedAsphalt Flushing/Bleeding Noted						
Number	of Samples:		Asphalt Surface Segregation/Cracking Noted						
Additional Notes:			Contact EXP for Retesting						
						J			
Report Distrib									
2561603 Ontario Ltd Zachary Rachar			zrachar@cjdleng.com Site Inspecto						
CJDL - Jeff Vickers CJDL - Cameron Cluett			jvickers@cjdleng.com J. Guenther						
CJDL - Camer CJDL - Deren			cluett@cjdleng llyle@cjdleng.c	50					
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Project No.: LON-23002025-A0 100

Eagle Ridge Subdivision - Phase 2, Central Elgin, ON

Project Location: Southdale Line

Central Elgin, ON

Report No.: 2023-11

Date Tested: Sep 21, 2023

Contractor: Titan

Test No.	Test Location and De	epth	Material Description	Test Results	s Comments
1	3m west, 1m south at subgrade		Silty clay	Pass	
2	4m west, 3m north at subgrade		Silty clay	Pass	
3	4m west, 6m north at subgrade		Silty clay	Pass	
Com	paction Required:	Silty clay		98	% SPMDD
Com	ments				

Test locations referenced from specified manholes.

Test elevations referenced from subgrade.